


PROVIDE SOUL SHOPPE PEACE PATH STENCIL, PAINT (3 COLORS), AND LAYOUT FOR PEACE PATH PER SOULSHOPPE.COM, PRODUCT 16-2W-052

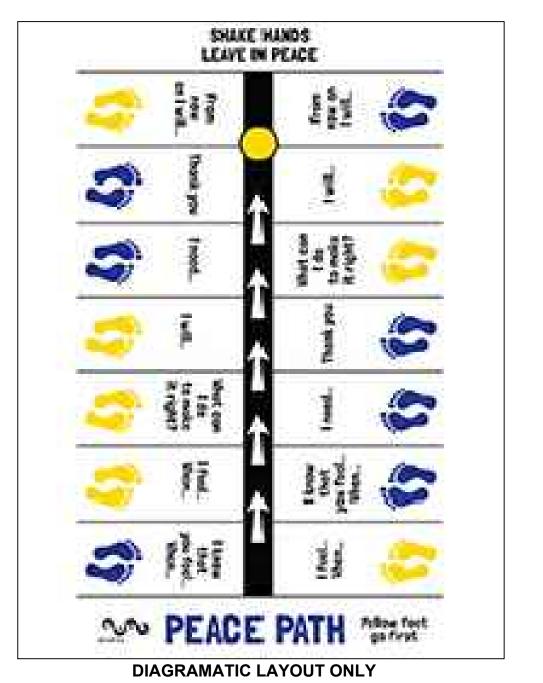

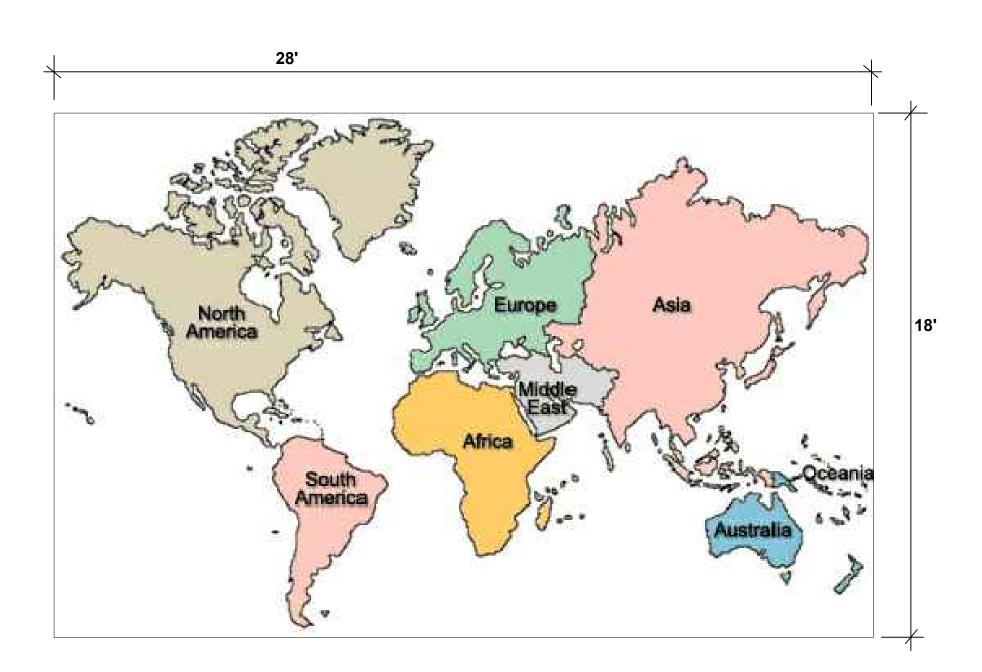

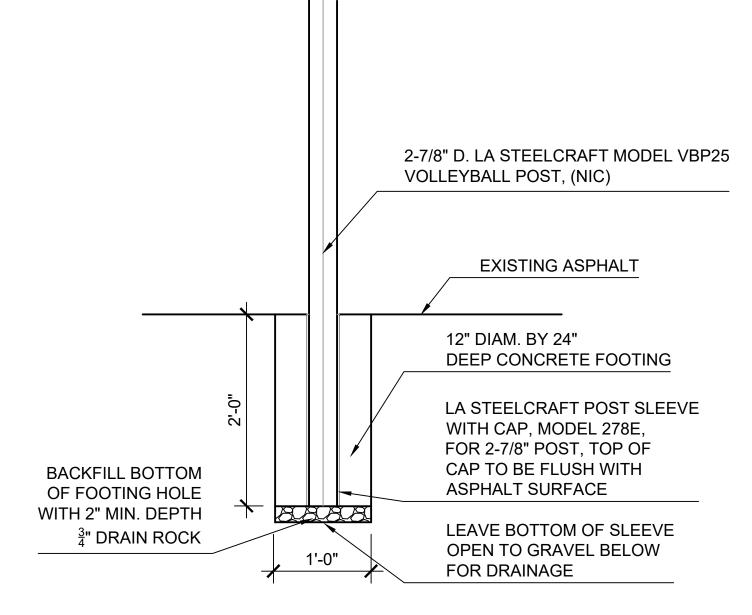

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Fax 415/258-9780 CA License #2616

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PEACE PATH

WORLD MAP

VOLLEYBALL POST FOOTINGS SCALE 1"=1'-0"

> Bid # 2018 / 19 Park School Garden/ **Paving-Striping-01**

Mill Valley School District 411 Sycamore Ave. Mill Valley, CA 94941

Drawing Title

Project

STRIPING/PAVING **DETAILS**

Date: February 15, 2019 Job #: 1807

Revisions

Sheet Number

PD-2


EXISTING BASKETBALL HOOP/POST EXISTING BASKETBALL HOOP/POST 12'-9" R= 4'-6" R= 6'-0" **BASKETBALL**, (8' HOOP HEIGHT) 1/4"=1'-0"

1/4"=1'-0"

KEYS TO BE CENTERED ON POSTS/HOOP, TYP.

(24" @ WOODY TRAIL) RED **BASKETBALL, (10' HOOP HEIGHT)**

POLY SPOT LAYOUT SCALE 1/4"=1'-0" TYPICAL COLOR LAYOUT, VERIFY FINAL WITH DISTRICT REP. YELLOW GREEN ORANGE **POLY SPOT and WOODY TRAIL LAYOUT** SCALE 1/4"=1'-0"

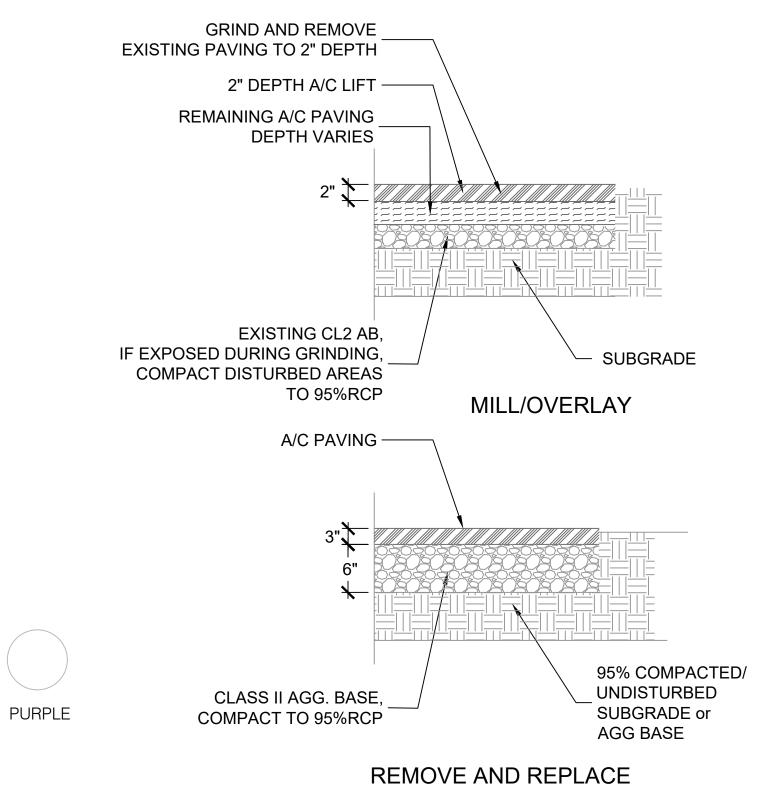


ASPHALT PAVING

SCALE NTS

WOODY TRAIL-POLY SPOT MARKINGS

13 Of 13 Sheets

BASKETBALL KEYS SCALE NTS

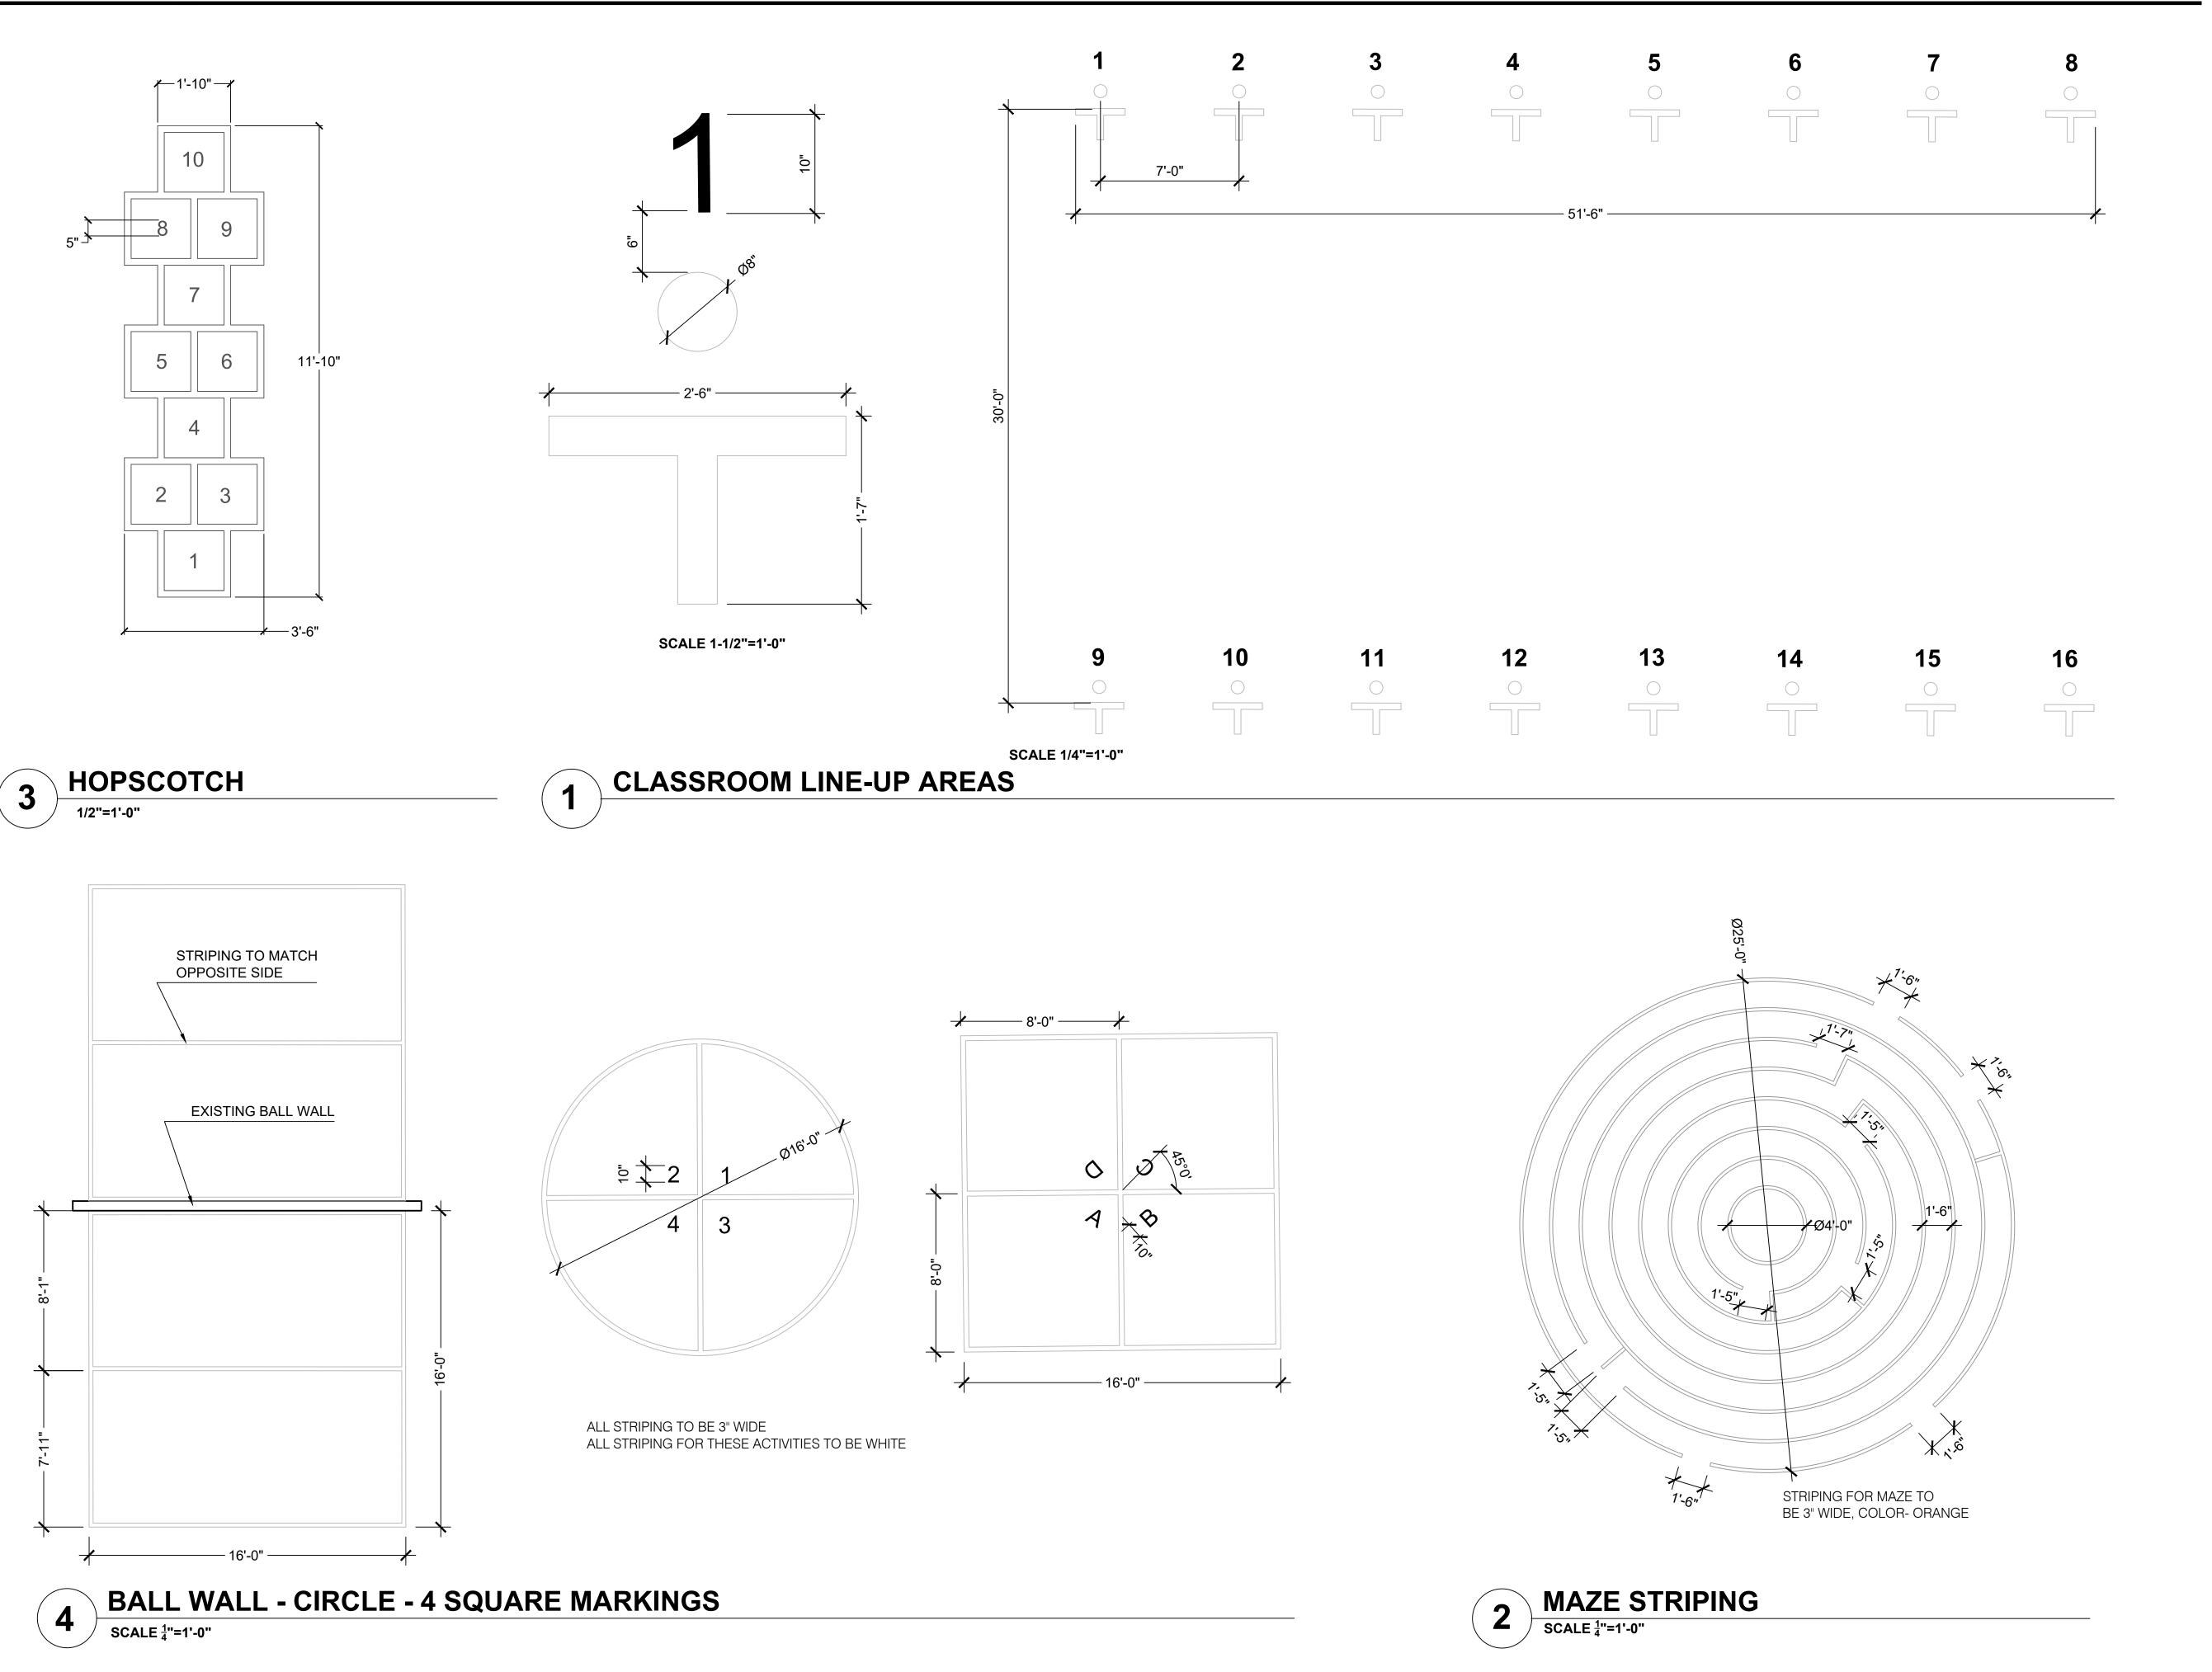

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LANDSCAPE ARCHITECTS

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Drawing Title


STRIPING/PAVING DETAILS

Date: February 15, 2019 Job #: 1807

Revisions

Sheet Number

PD-1

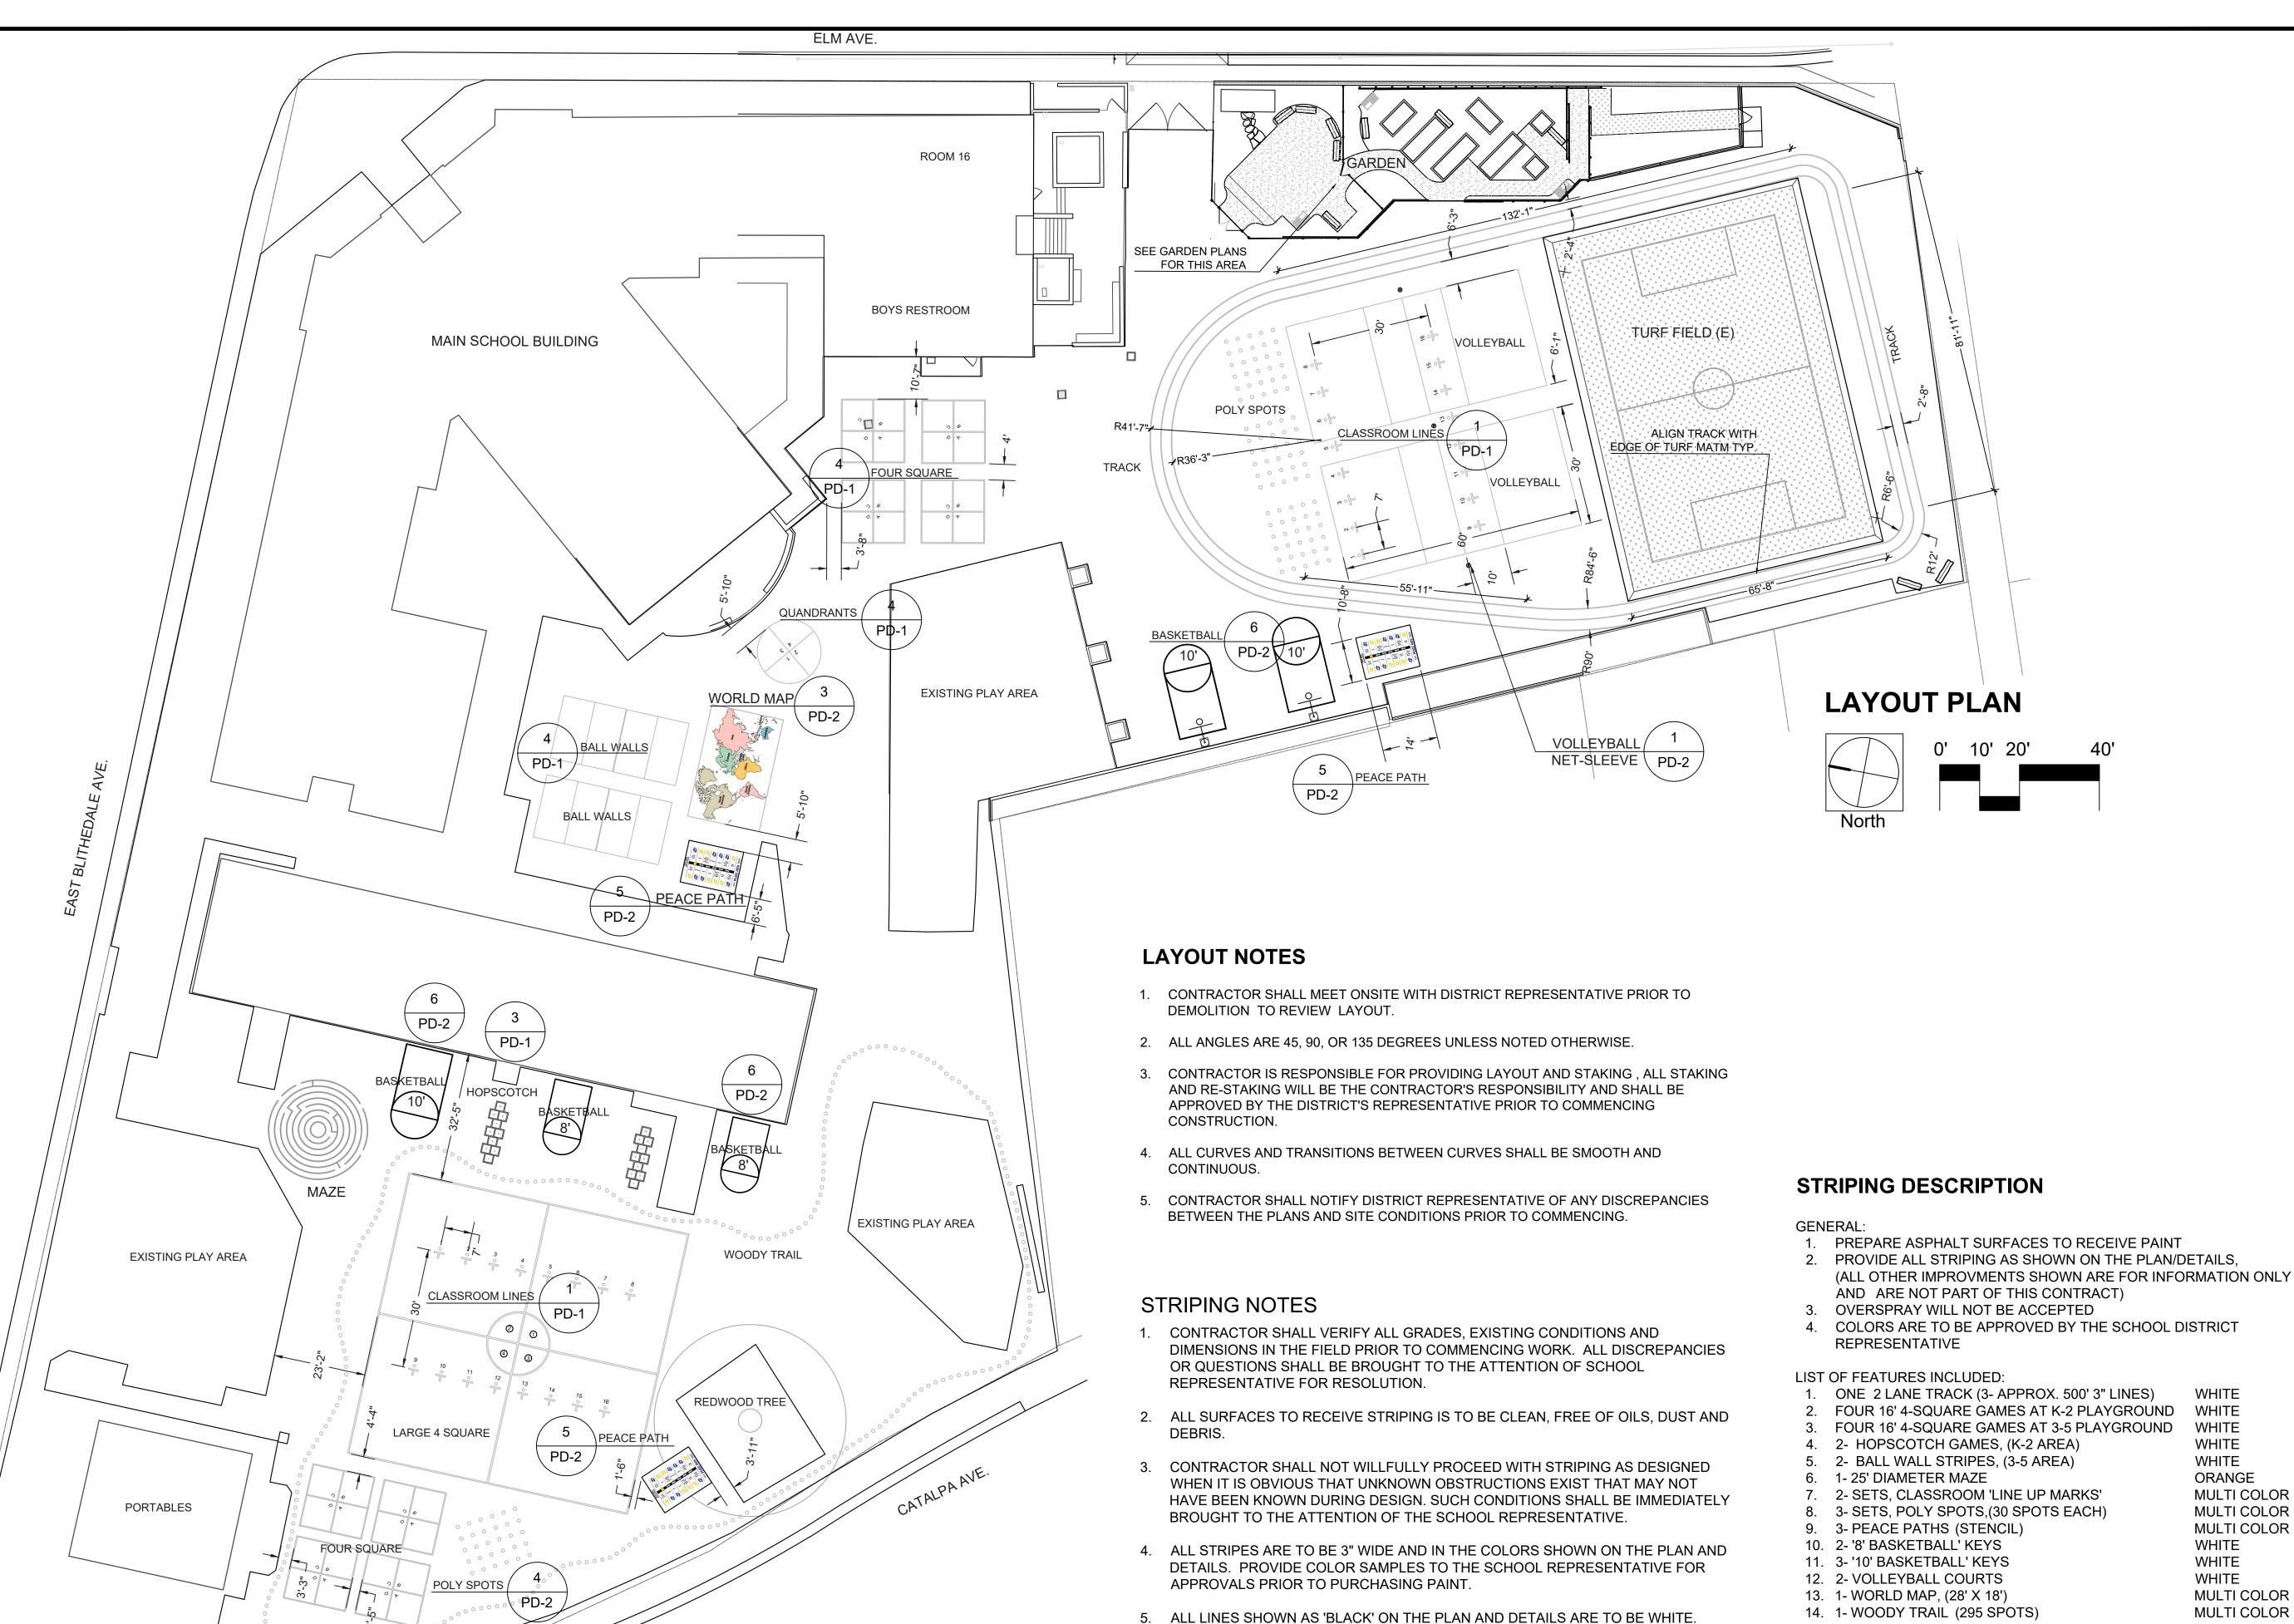

WOODY TRAIL

6. CONTRACTOR TO FOLLOW COUNTY OF MARIN SWPPP GUIDLINES FOR PROJECTS

OF LESS THAN 1 ACRE.

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Drawing Title

STRIPING PLAN

Date: February 15, 2019

Job #: 1807


Revisions

(ALL OTHER IMPROVMENTS SHOWN ARE FOR INFORMATION ONLY

- 14. 1- WOODY TRAIL (295 SPOTS)
- ORANGE **MULTI COLOR MULTI COLOR MULTI COLOR**

Sheet Number

S-1

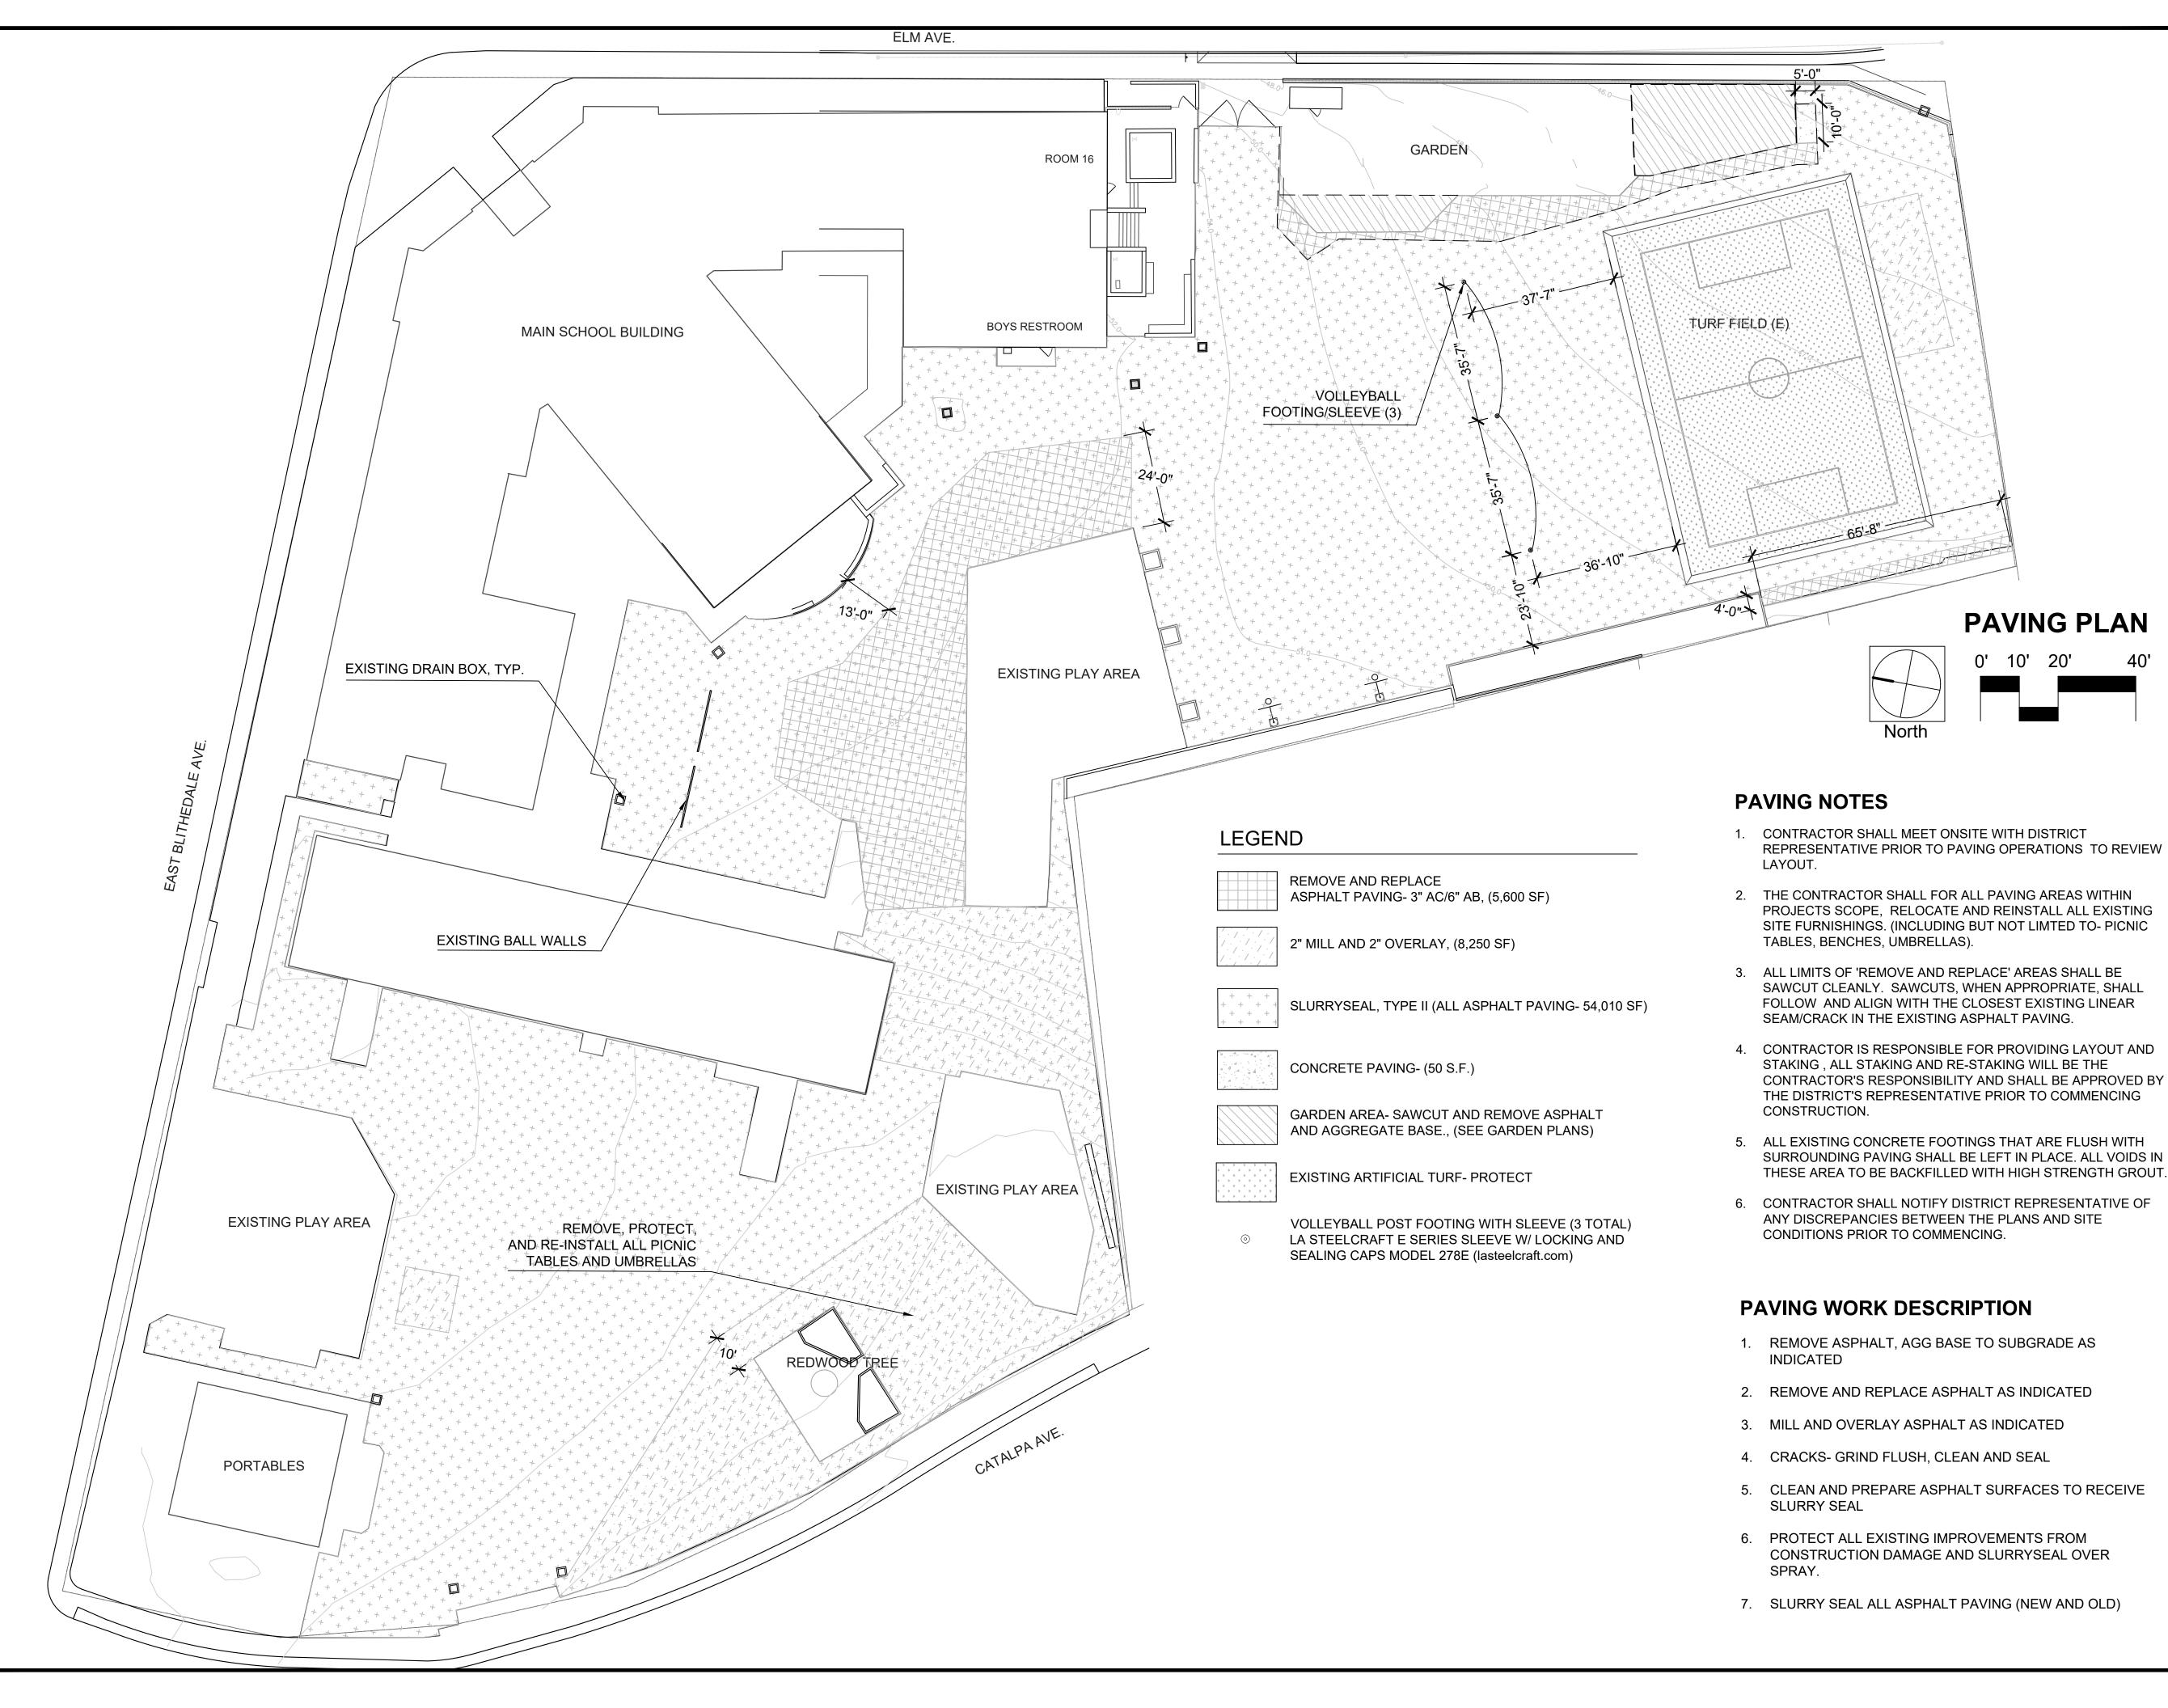



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Drawing Title

PAVING PLAN


Date: February 15, 2019

Job #: 1807

Revisions

Sheet Number


P-1

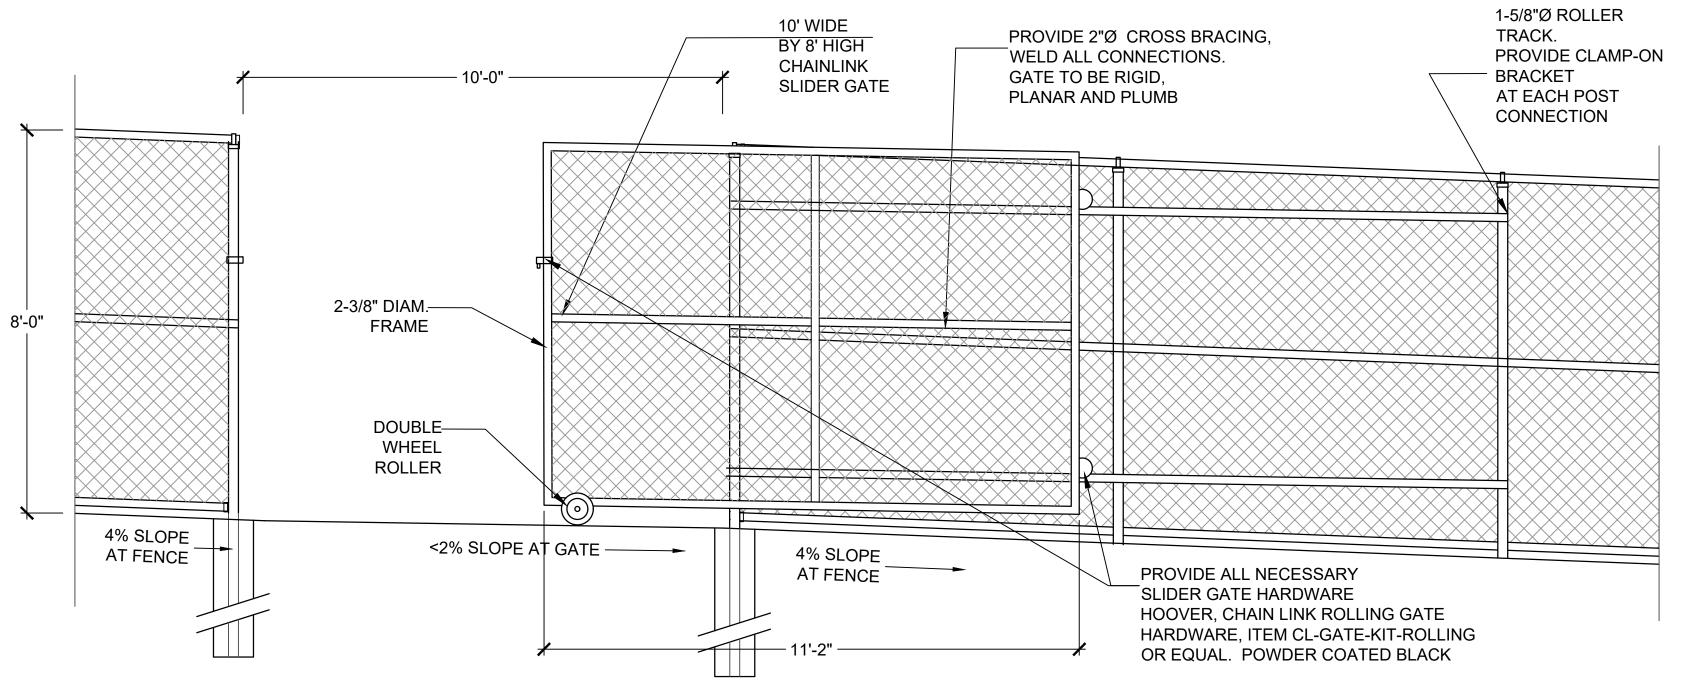

ROLLING GATE- MAINTENANCE ACCESS


1. ALL CONCRETE TO BE 3000PSI CLASS B. 2. ALL EXPOSED SURFACES TO BE MEDIUM BROOM 3. LANDING TO HAVE LESS THAN 2% SLOPE ALL

DIRECTIONS. RAMP TO HAVE LESS THAN 2% CROSS SLOPE AND MAX 8% RUN SLOPE .

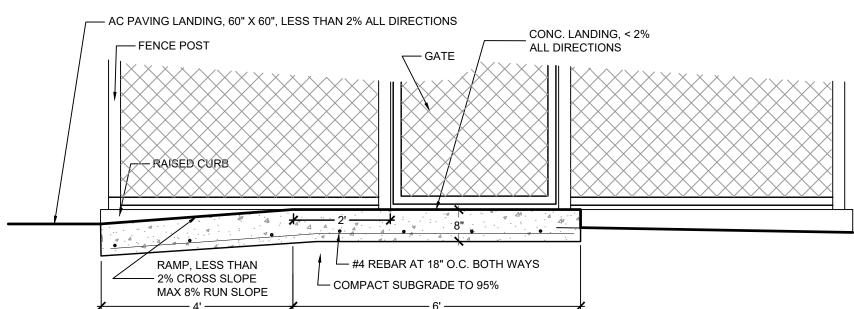


LANDING/RAMP SCALE 1/2"=1'-0"

SCALE 1/2"=1'-0"

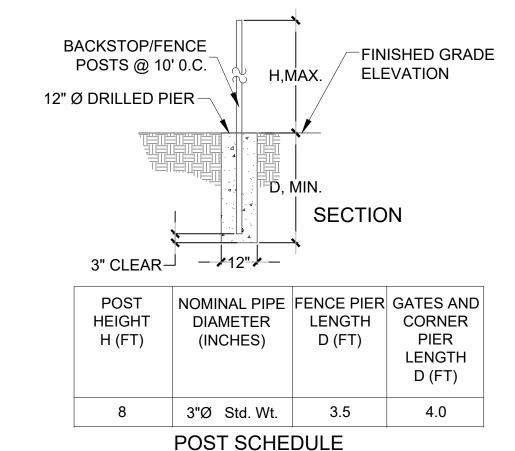

FENCE POST NOTES


- 1. ALL STEEL PIPES: ASTM A53, Fy=35KSI
- 2. CONCRETE COMPRESSIVE STRENGTH:f'c=3,000 PSI @ 28 DAYS
- 3. SEE DETAIL FOR DEFINITION OF PARAMETERS AND OTHER REQUIREMENTS
- 4. LINE POSTS ARE TO BE SCH 40, CORNER AND GATE POSTS TO BE SCH 80
- 5. DRILLED PIERS: REMOVE SLOUGHAGE OR OTHER LOOSE MATERIAL IN HOLES. NO WATER IS PERMITTED IN HOLES AT TIME OF PLACING CONRETE. FINAL POSITION OF PIER SHALL NOT VARY BY MORE THAN 1" AT ANY POINT FROM STRAIGHT LINE DRAWN BETWEEN CENTER OF HOLE AT TOP AND BOTTOM. CENTER OF PIER (TOP) SHALL NOT DEVIATE FROM LOCATION SHOWN BY MORE THAN 1-1/2" IN ANY DIRECTION.
- 6. PIPES SPACING IS 10'-0" MAX. O.C.

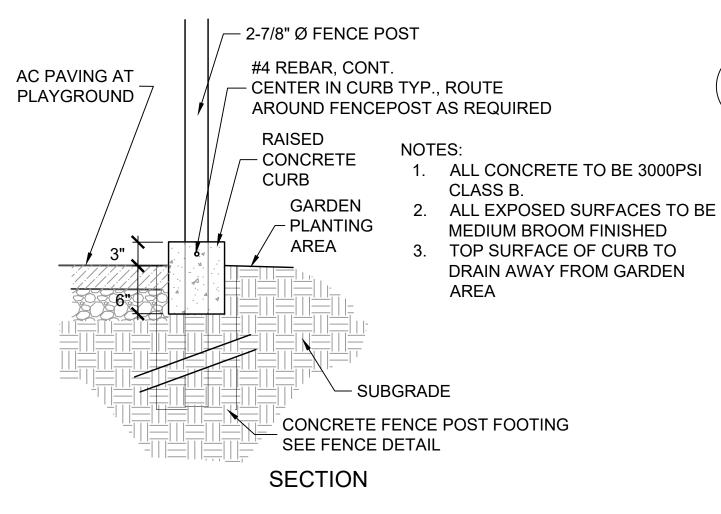


RAISED CURB AT FENCE SCALE 1"=1'-0"

GENERAL FENCING NOTES:

- 1. ALL POSTS, RAILS, GATES AND ASSOCIATED HARDWARE ARE TO BE POWDER COATED BLACK GALVANIZED STEEL
- 2. CONCRETE FOOTINGS PER SPECS.
- 3. ALL CHAINLINK MESH IS TO HAVE 2" OPENINGS, 9 GAUGE CORE, WITH BLACK THERMAFUSED FINISH.
- 4. FOUNDATION REQUIREMENTS FOR FENCE GATES ARE SAME AS CORNER POSTS
- 5. ALL GATE FRAMES ARE TO BE WELDED, NO SLEEVED CONNECTIONS ALLOWED. GRIND ALL WELDS SMOOTH, POWDERCOAT FINISH, TYP.

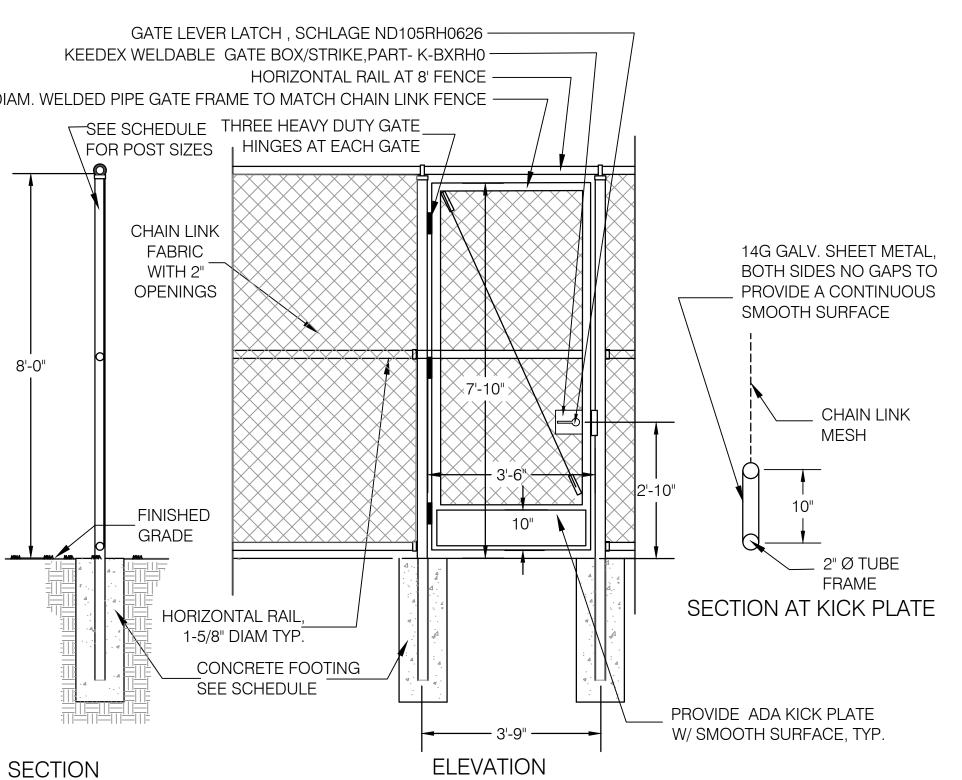

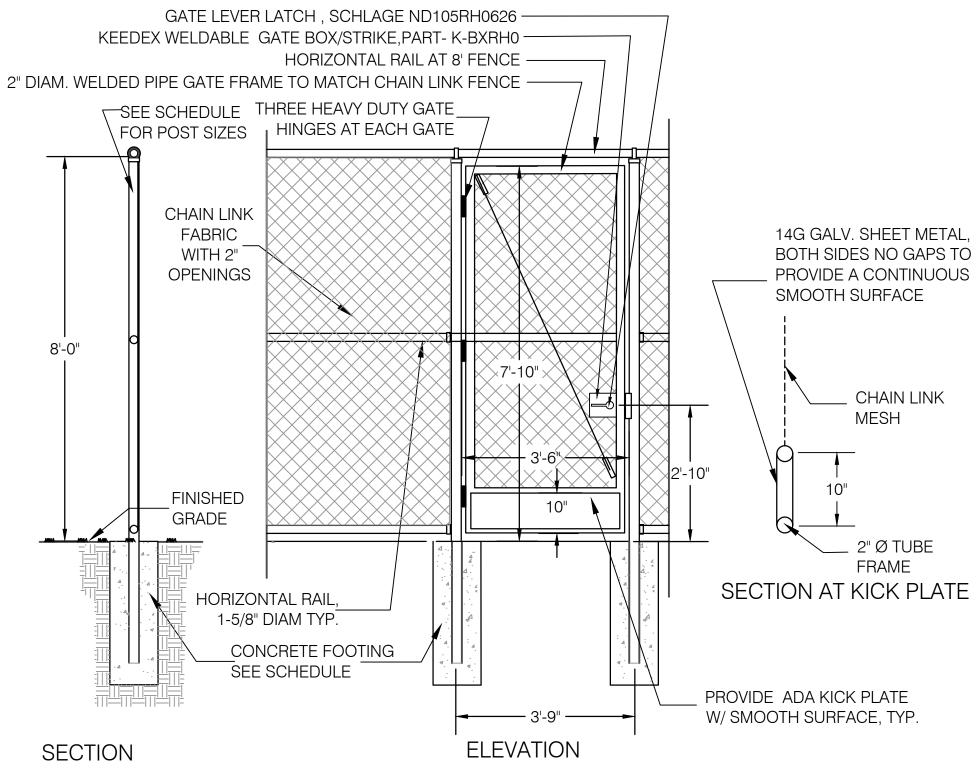


CHAIN LINK GATE SCALE 1/2"=1'-0"

SCALE 1/2"=1'-0"

NOTES

- 1. PROVIDE 2 ADJUSTABLE TRUSS RODS, TURNBUCKLES AND ASSOCIATED HARDWARE AT EACH CORNER POST
- 2. CORNER POSTS TO BE 2-7/8" DIAM. SCHEDULE 80 WITH 48" DEPTH BY 12" DIAM.
- 3. PROVIDE TENSION BARS AND ASSOCIATED HARDWARE AS NECESSARY.
- 4. ALL SHARP EDGES TO BE FILED OR GROUND SMOOTH.
- 5. ALL TUBING AND HARDWARE TO BE GALVANIZED AND POWDER COATED MATTE
- 6. MESH TO BE INSTALLED ON PLAYGROUND SIDE OF POSTS/RAILS.

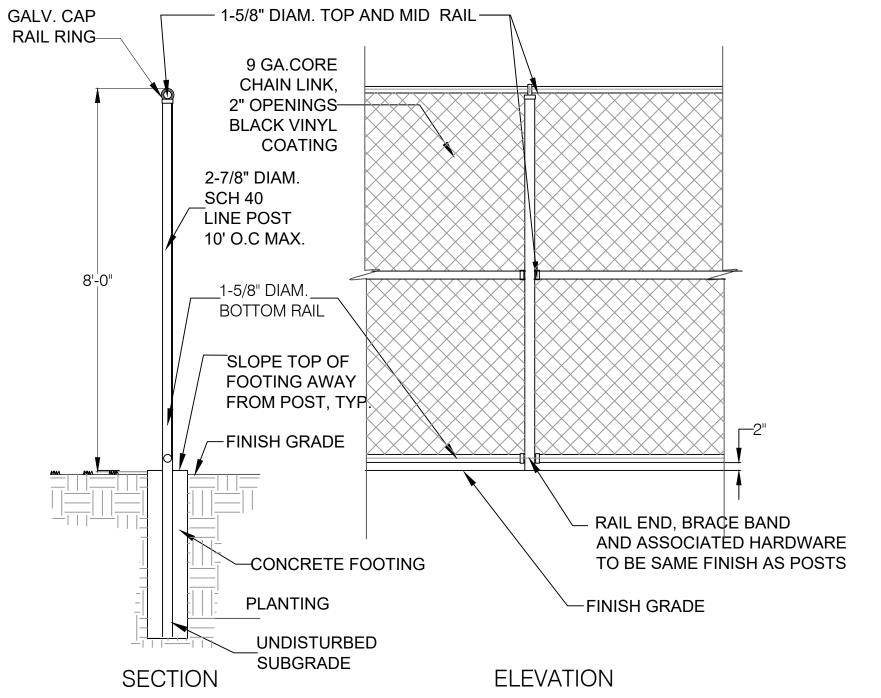

8' HEIGHT CHAIN LINK FENCING

Sheet Number **L-5**

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Phone 415-258-9580

Fax 415/258-9780

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Bid # 2018 / 19

Paving-Striping- 01

Mill Valley School District

CONSTRUCTION

Date: February 15, 2019

Job #: 1807

Revisions

411 Sycamore Ave.

Drawing Title

DETAILS

Mill Valley, CA 94941


Park School


Garden/


Project

San Rafael, California 94901


FENCE NOTES AND POST FOUNDATIONS 6 SCALE 1"=1'-0"

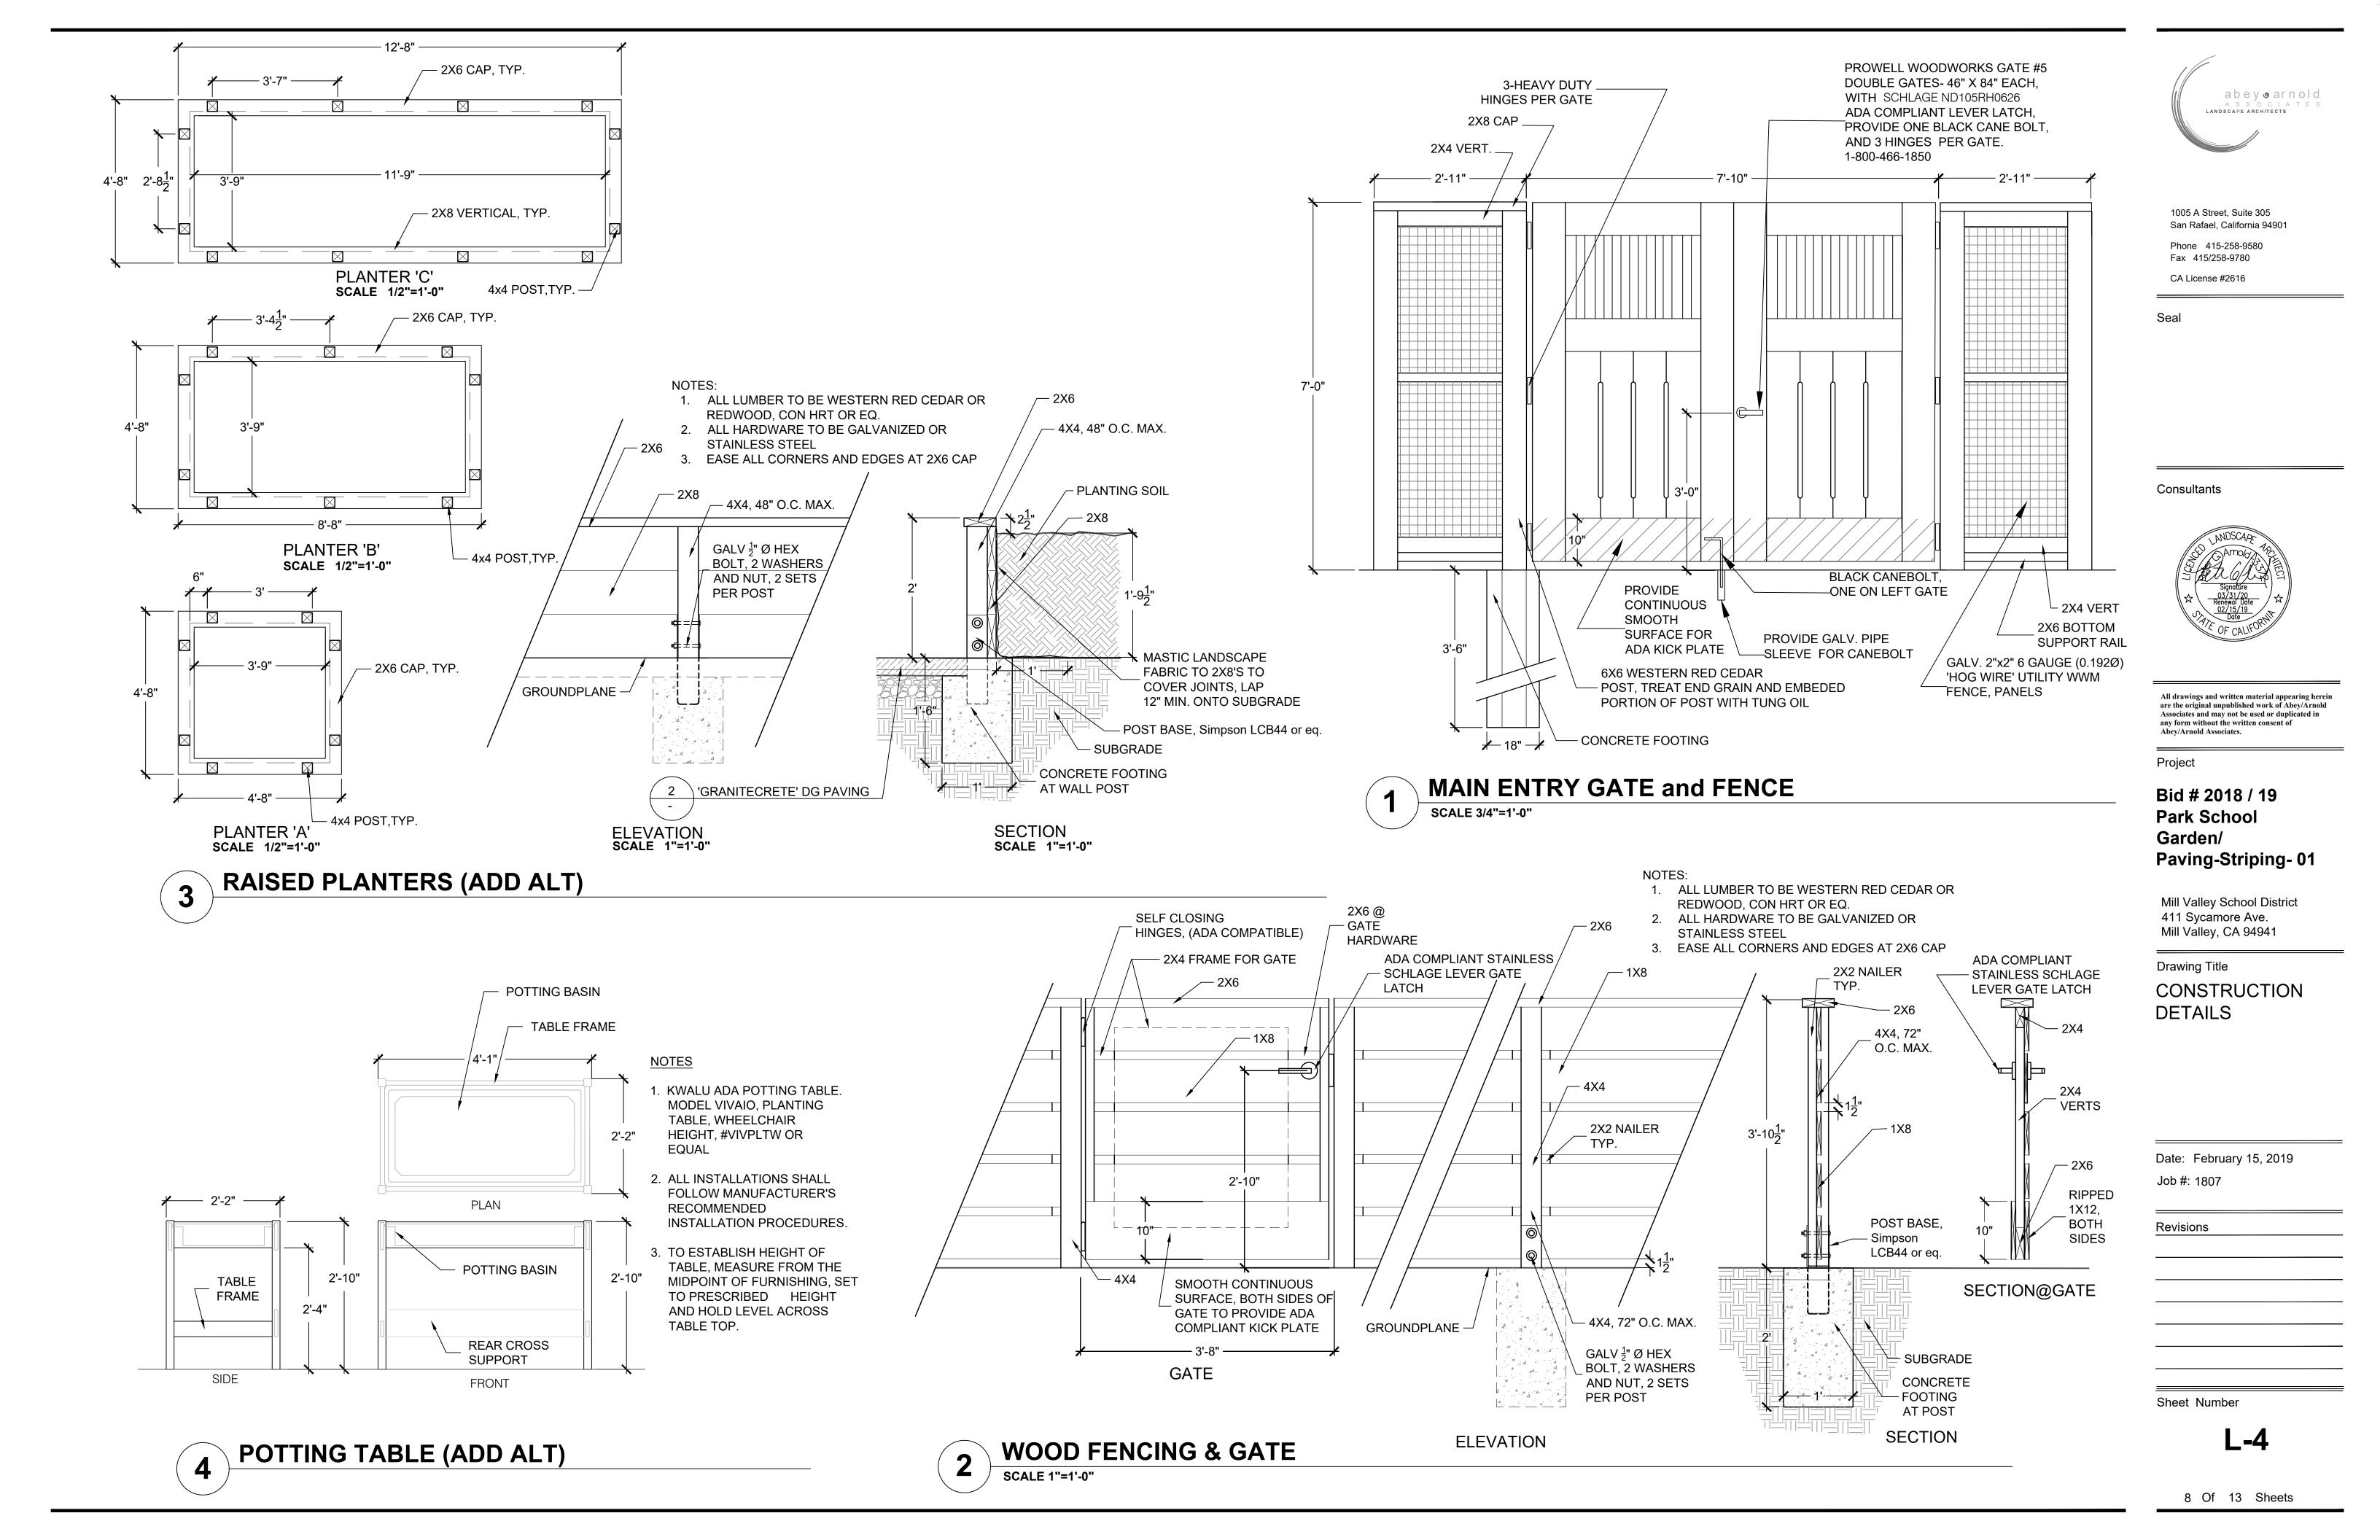

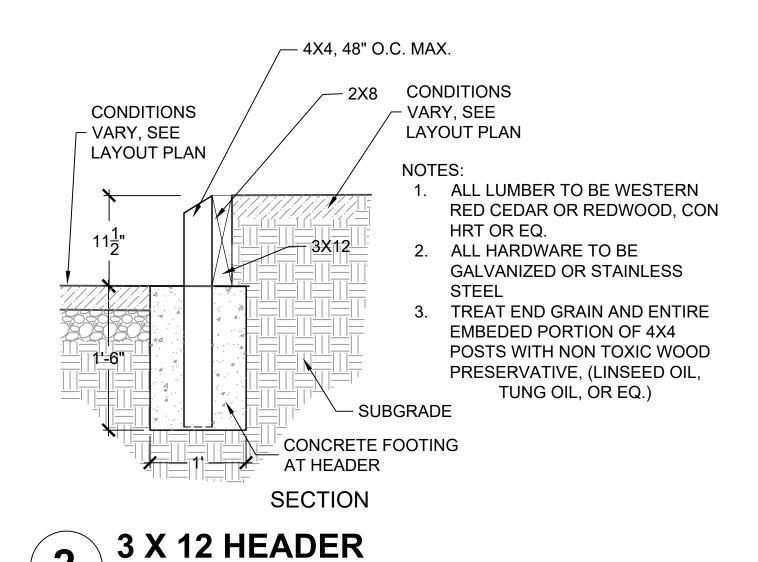

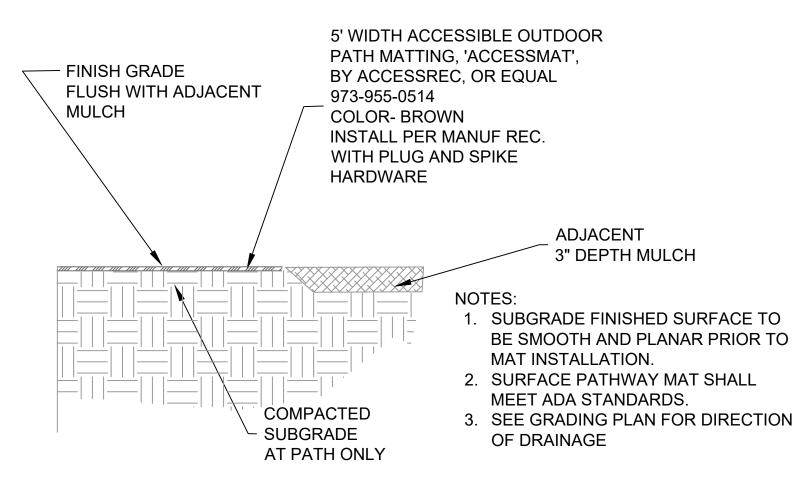




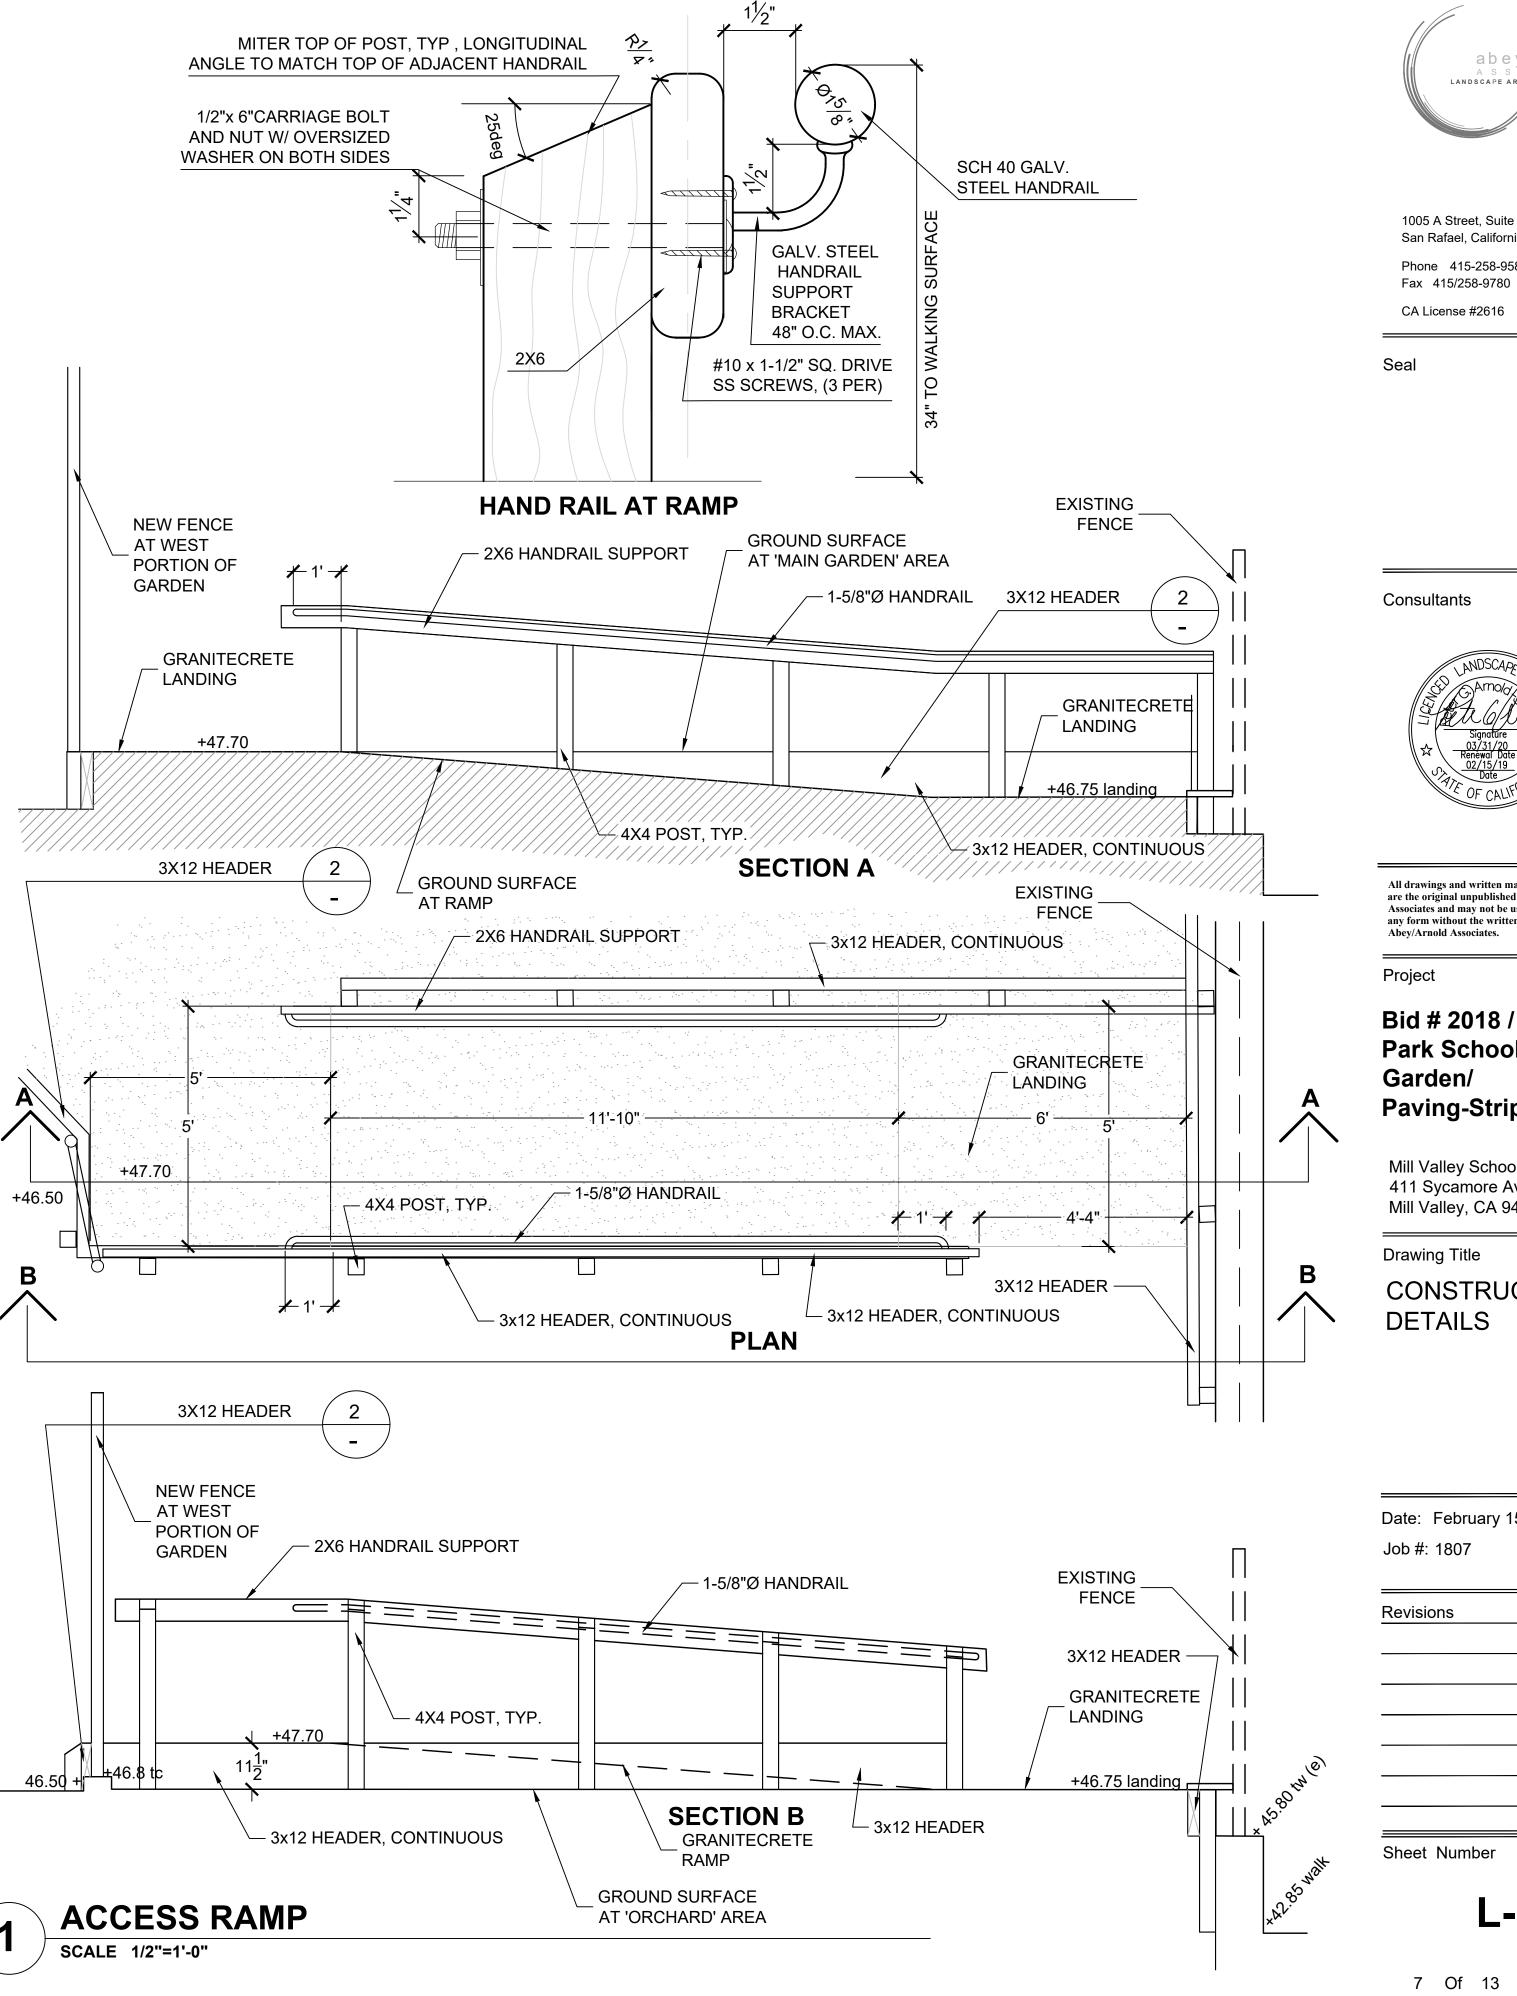

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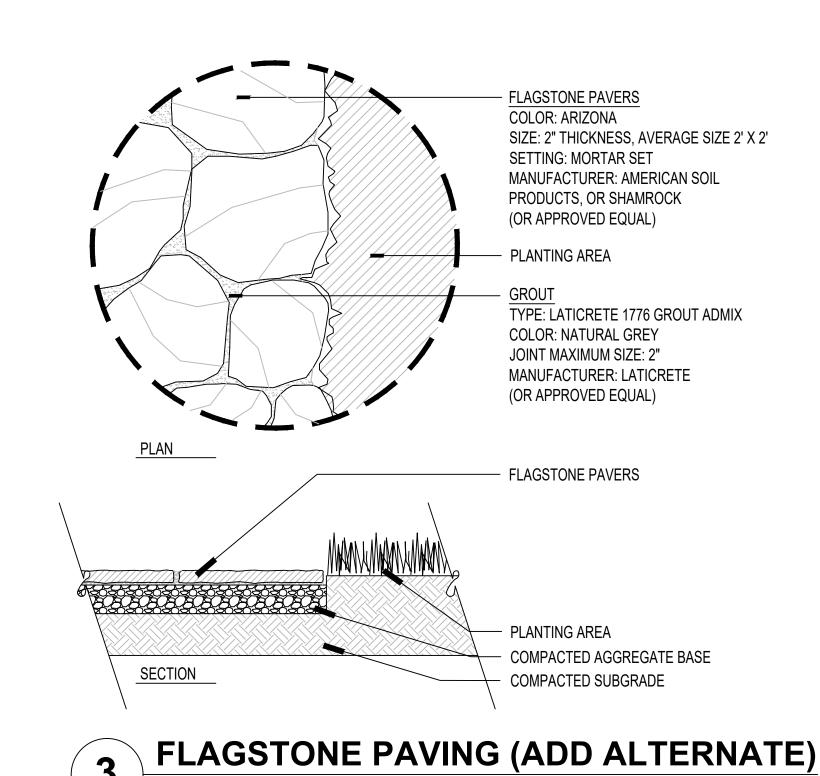
Mill Valley School District 411 Sycamore Ave. Mill Valley, CA 94941

Drawing Title

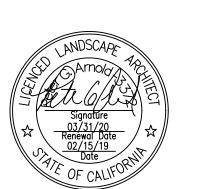
CONSTRUCTION **DETAILS**

Date: February 15, 2019 Job #: 1807


L-3




(Base Bid- GraniteCrete Paving)

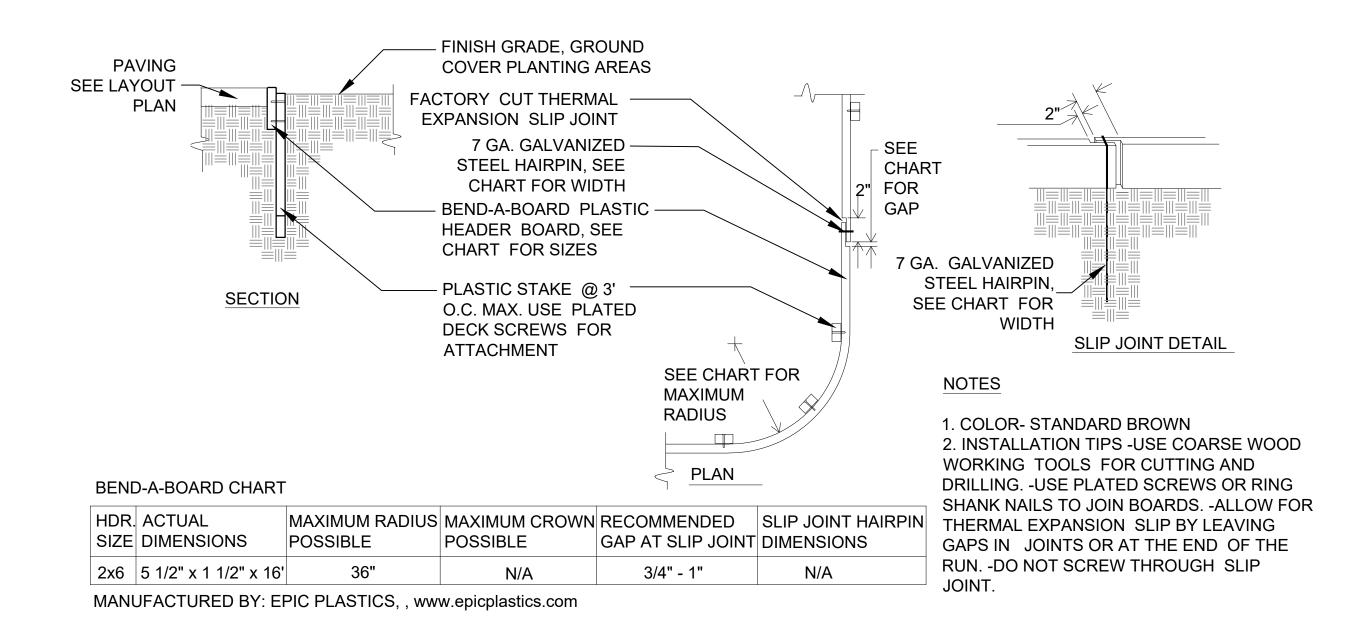

PAVING CONTAINMENT HEADER SCALE NTS

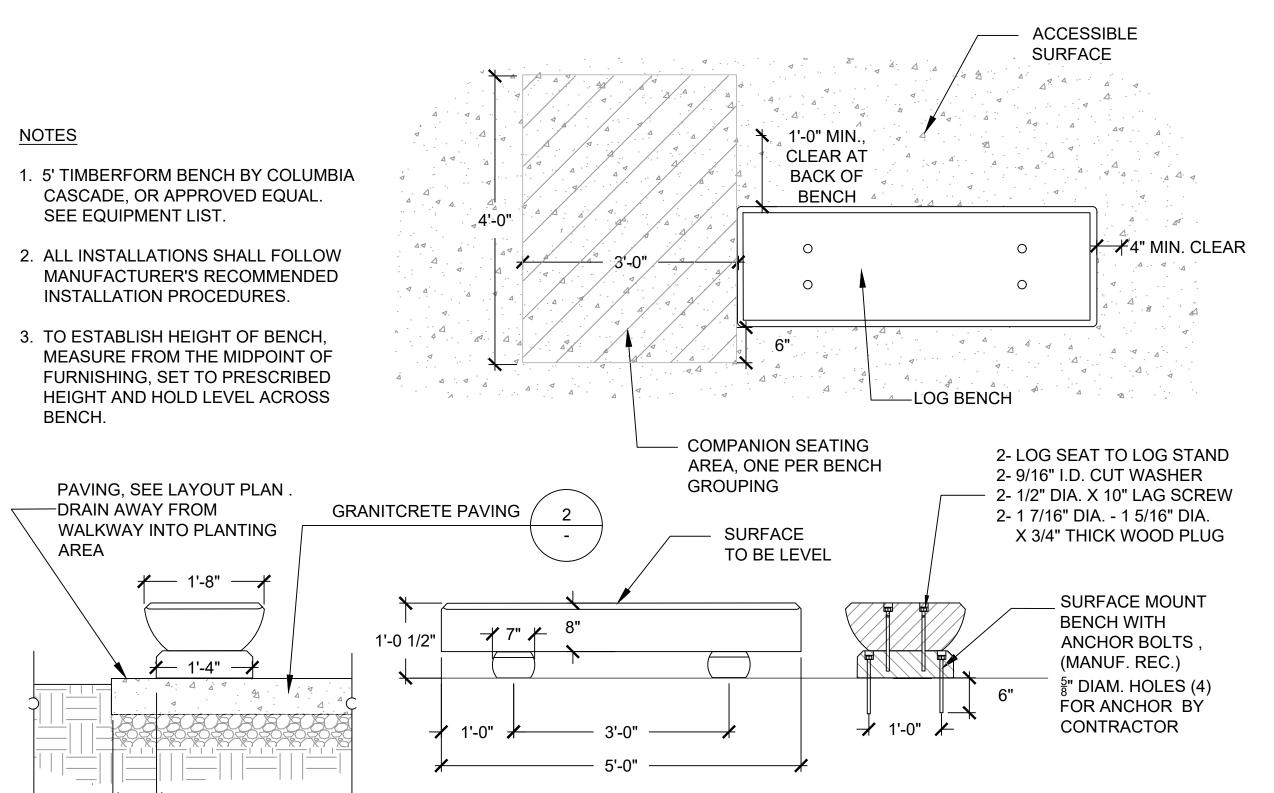

TIMBER BENCH SCALE 3/4"=1'-0"

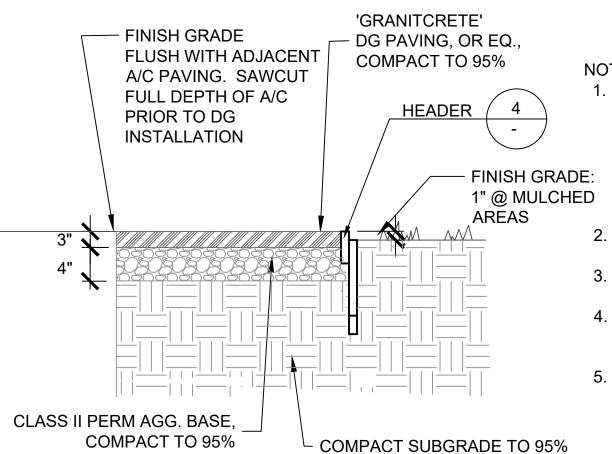

NOTES:

- 1. DECOMPOSED GRANITE TO BE ¹/₈"-MINUS FINES, GOLD/TAN IN COLOR WITH GRANITECRETE (OR EQ) STABILIZING ADDITIVE, (170 LBS PER CUBIC YARD), INSTALLED PER MANUF INSTRUCTIONS. SUBMIT SAMPLE FOR APPROVAL. 2. SURFACE FINISH OF GRANITECRETE
- SHALL MEET ADA STANDARDS. 3. SEE GRADING PLAN FOR DIRECTION OF DRAINAGE.
- 4. EDGING IS REQUIRED WHERE NO OTHER STRUCTURE EXISTS FOR USE AS A BORDER.
- 5. WHERE DECOMPOSED GRANITE PAVING ABUTS A/C PAVING, FINISH SURFACE OF DG SHALL BE FLUSH WITH A/C.

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> 1005 A Street, Suite 305 San Rafael, California 94901

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Drawing Title

CONSTRUCTION **DETAILS**


Date: February 15, 2019 Job #: 1807

Revisions

Sheet Number

L-2

GRANITECRETE PAVING SCALE 1"=1'-0"

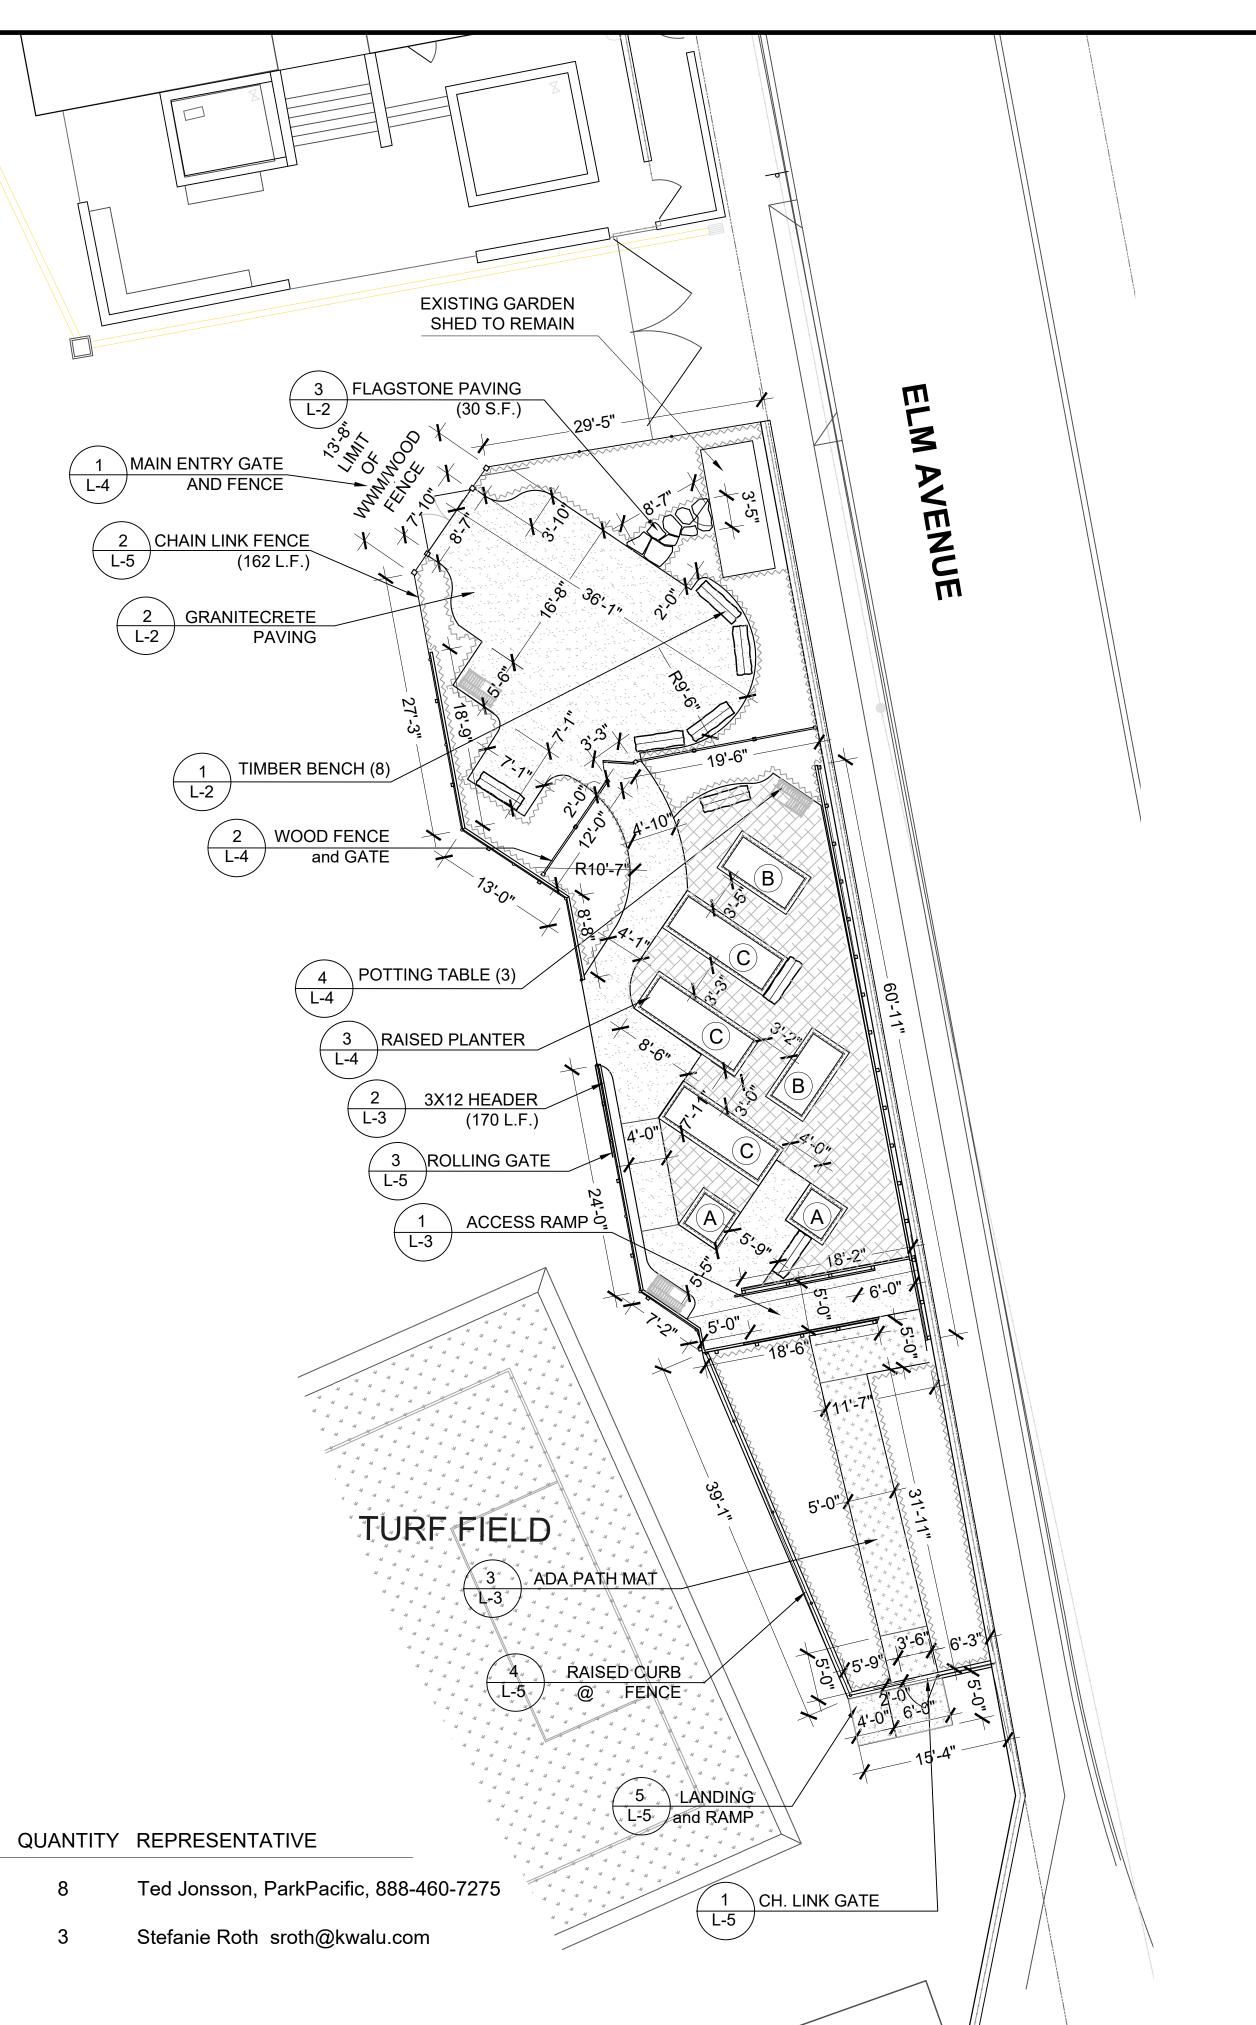

EQUIPMENT LIST

MANUFACTURER

KUALU

COLUMBIA CASCADE

MODEL

VIVAIO

TIMBERFORM - 5' LENGTH

DESCRIPTION

POTTING TABLE

BENCH



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PLANTING AREA

BARK MULCH SURFACE

RAISED PLANTER - see detail

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Project

Bid # 2018 / 19
Park School
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Paving-Striping- 01

Mill Valley School District 411 Sycamore Ave. Mill Valley, CA 94941

Drawing Title

LAYOUT PLAN

Date: February 15, 2019

Job #: 1807

Revisions

Sheet Number

L-1

5 Of 13 Sheets

LAYOUT NOTES

SURFACE MATERIAL LEGEND

GRANITECRETE PAVING

PATHWAY MATTING

CONCRETE PAVING


- CONTRACTOR SHALL MEET ONSITE WITH DISTRICT REPRESENTATIVE PRIOR TO DEMOLITION TO REVIEW LAYOUT.
- 2. CONTRACTOR IS RESPONSIBLE FOR LOCATING AND CAPPING EXISTING IRRIGATION EQUIPMENT AS SHOWN ON PLANS. SALVAGE ALL EXISTING IRRIGATION EQUIPMENT AND HAND OVER TO DISTRICT MAINTENANCE STAFF.
- 3. CONTRACTOR SHALL NOTIFY USA ALERT (UNDERGROUND SERVICE ALERT) AT 1(800) 227-2600 PRIOR TO CONSTRUCTION.
- 4. ALL ANGLES ARE 45, 90, OR 135 DEGREES UNLESS NOTED OTHERWISE.
- 5. CONTRACTOR IS RESPONSIBLE FOR PROVIDING LAYOUT AND STAKING, ALL STAKING AND RE-STAKING WILL BE THE CONTRACTOR'S RESPONSIBILITY AND SHALL BE APPROVED BY THE DISTRICT'S REPRESENTATIVE PRIOR TO COMMENCING CONSTRUCTION.
- 6. ALL CURVES AND TRANSITIONS BETWEEN CURVES SHALL BE SMOOTH AND CONTINUOUS.
- 7. CONTRACTOR SHALL NOTIFY DISTRICT REPRESENTATIVE OF ANY DISCREPANCIES BETWEEN THE PLANS AND SITE CONDITIONS PRIOR TO COMMENCING.

ACCESSIBLE PATH OF TRAVEL AS INDICATED ON PLAN IS A BARRIER FREE ACCESS PATH OF TRAVEL WITHOUT ANY ABRUPT LEVEL CHANGES EXCEEDING ½" BEVELED AT 1:2 MAX. SLOPE, OR VERTICAL LEVEL CHANGES NOT EXCEEDING ¼" MAX. AND AT LEAST 48" WIDE. SURFACE IS SLIP RESISTANT, STABLE, FIRM, AND SMOOTH. CROSS SLOPE DOES NOT EXCEED 2% AND SLOPE IN THE DIRECTION OF TRAVEL IS LESS THAN 5% UNLESS OTHERWISE INDICATED. (SEE SHEET G-1)

5' 10'

LAYOUT PLAN

0'

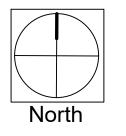


SURFACE MATERIAL LEGEND

GRANITECRETE PAVING PLANTING AREA BARK MULCH SURFACE ADA PATHWAY MATTING (TOP OF MULCH TO BE 1" BELOW PAVING FINISHED GRADE)

ASPHALT PAVING (N)

CONCRETE PAVING

60" DIAMETER WHEELCHAIR **TURNING CIRCLE**

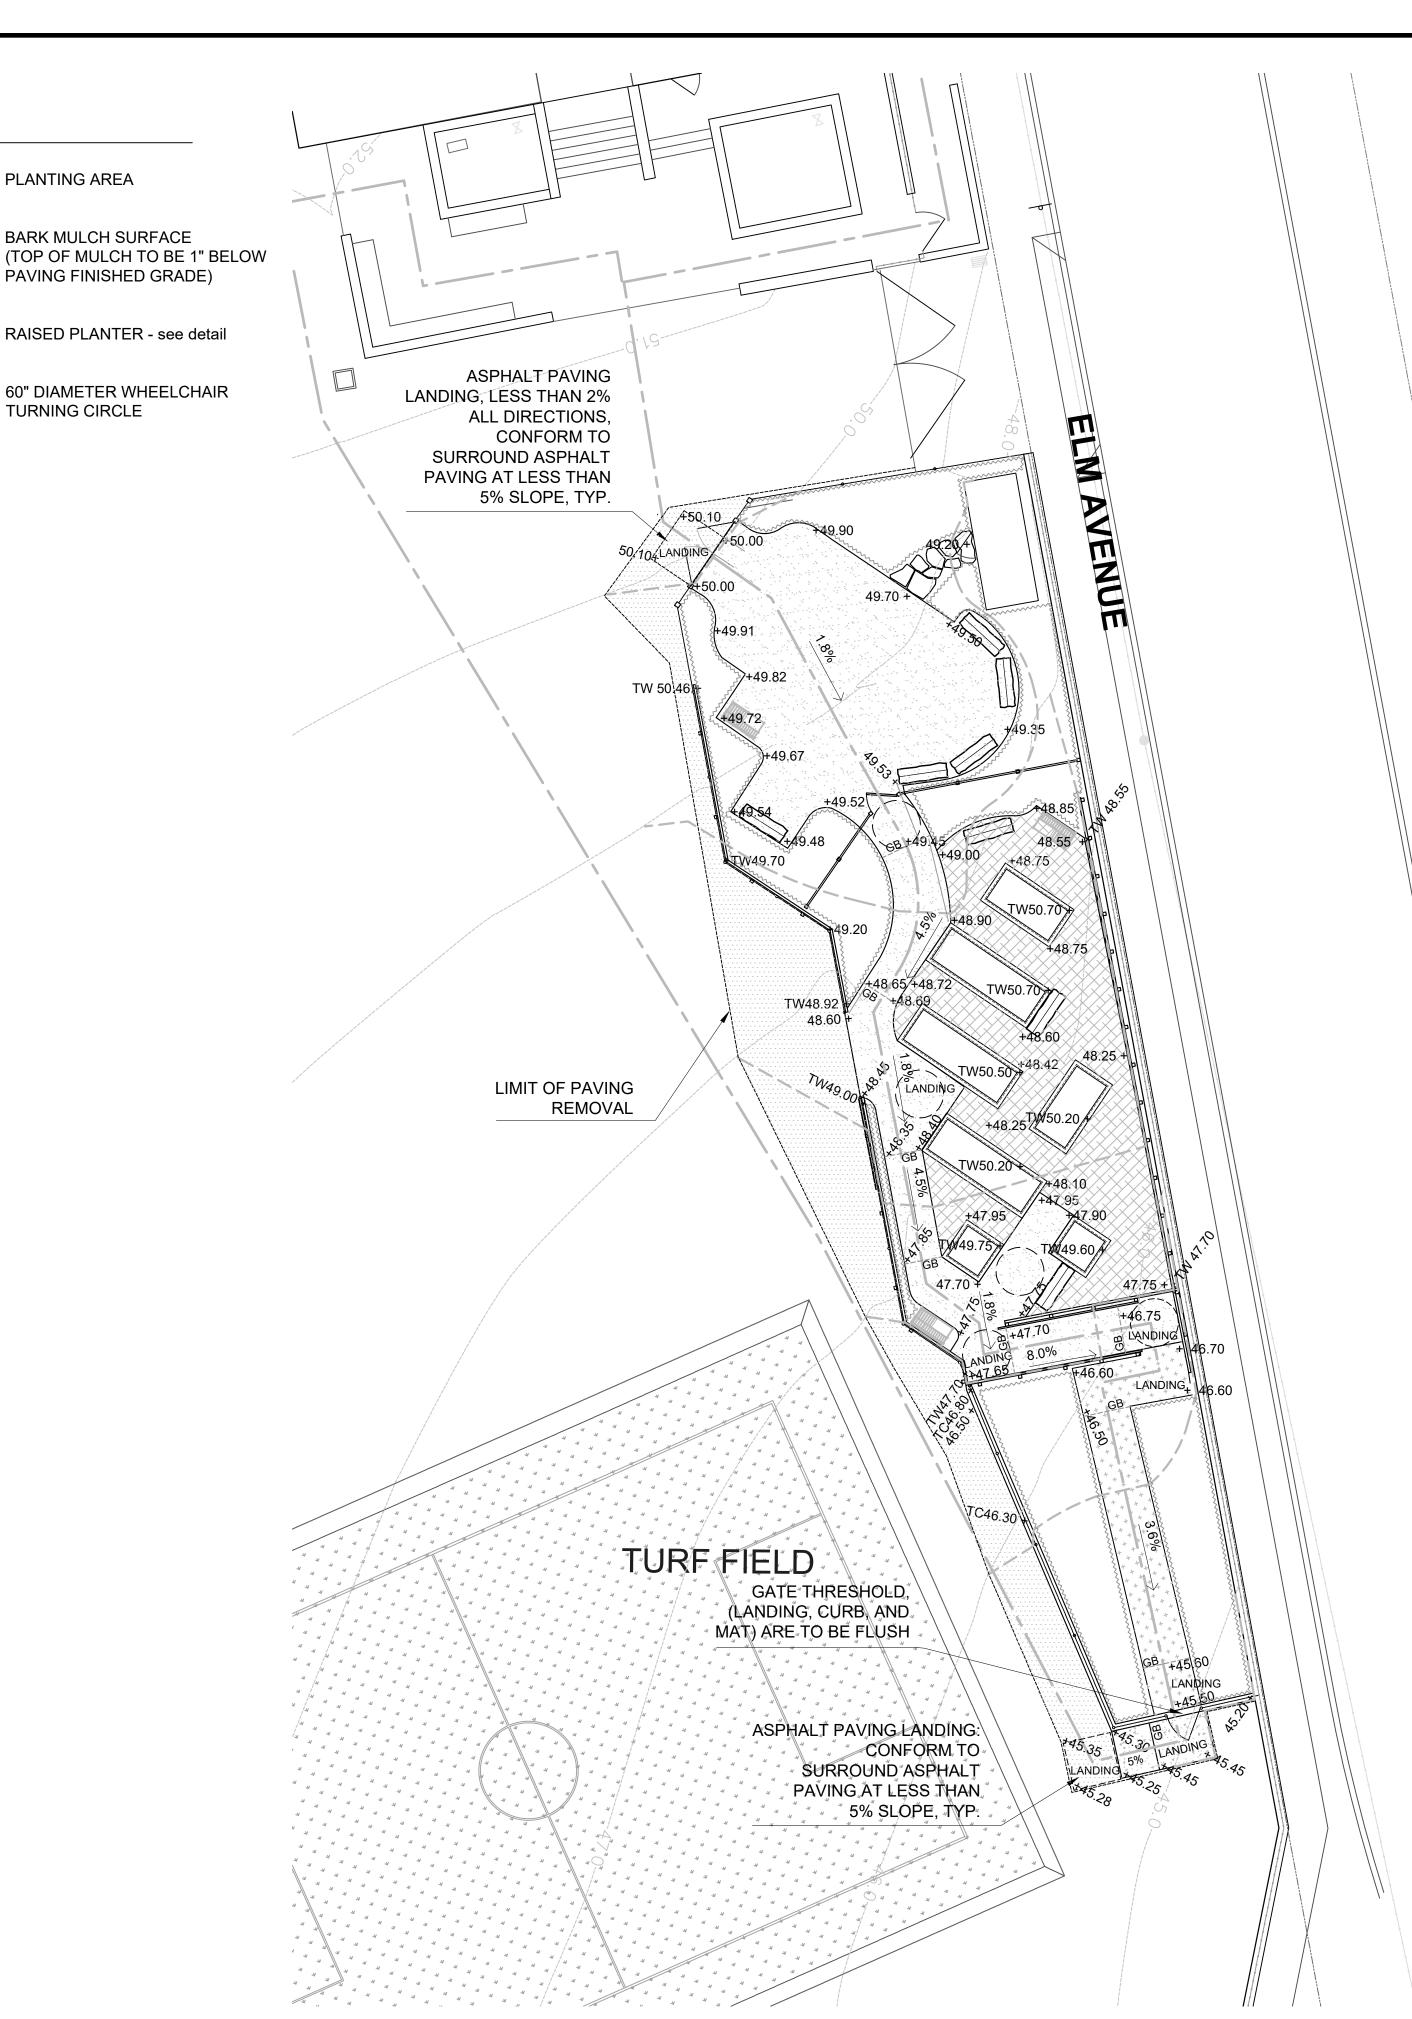


GRADING/DRAINAGE LEGEND

x0.00 **EXISTING ELEVATION** x0.00 C **EXISTING CONCRETE ELEVATION** x0.00 EP **EXISTING PAVING ELEVATION** x0.00 TC EXISTING TOP OF CURB ELEVATION PROPOSED PAVING FINISHED GRADE + 0.00 + 0.00 SG SUB-GRADE ELEVATION + 0.00 TC TOP OF CURB ELEVATION + TW 0.00 TOP OF WALL **DIRECTION OF** SURFACE FLOW GRADE BREAK **EXISTING CONTOUR** PROPOSED CONTOUR ————— ACCESSIBLE PATH OF TRAVEL

GRADING NOTES

- 1. CONTRACTOR SHALL VERIFY ALL GRADES, EXISTING CONDITIONS AND DIMENSIONS IN THE FIELD PRIOR TO COMMENCING WORK. ALL DISCREPANCIES OR QUESTIONS SHALL BE BROUGHT TO THE ATTENTION OF THE ENGINEER / PROJECT COORDINATOR FOR RESOLUTION.
- 2. CONTRACTOR SHALL BE RESPONSIBLE FOR MAKING HIMSELF FAMILIAR WITH ALL UNDERGROUND UTILITIES, PIPES AND STRUCTURES. CONTRACTOR SHALL TAKE SOLE RESPONSIBILITY FOR COSTS INCURRED DUE TO DAMAGE AND REPLACEMENT OF SAID UTILITIES.
- 3. CONTRACTOR SHALL NOT WILLFULLY PROCEED WITH CONSTRUCTION AS DESIGNED WHEN IT IS OBVIOUS THAT UNKNOWN OBSTRUCTIONS AND/OR GRADE DIFFERENCES EXIST THAT MAY NOT HAVE BEEN KNOWN DURING DESIGN. SUCH CONDITIONS SHALL BE IMMEDIATELY BROUGHT TO THE ATTENTION OF THE ENGINEER.
- 4. CONTRACTOR TO PROVIDE ALL FITTINGS REQUIRED PER MANUFACTURER'S RECOMMENDATIONS FOR TRANSITION FROM PANEL DRAINS TO 4"D DRAIN LINES AT PERIMETER OF BOCCE COURTS. (4 PER COURT, 16 TOTAL). 90 DEGREE ELL FITTINGS NOT ALLOWED, PROVIDE 2-45 ELLS AT TURNS.
- 5. MINIMUM SLOPE ON PAVING SHALL BE 1% MIN. AND 4.5% MAX. (UNLESS NOTED OTHERWISE)
- 6. CROSS SLOPE ON WALKWAYS SHALL NOT EXCEED 2%.
- 7. ALL UTILITY BOXES WITHIN PAVED AND LANDSCAPED AREAS ARE TO BE ADJUSTED AND/OR EXTENDED TO NEW FINISHED GRADES.
- 8. CONTRACTOR TO PROVIDE, INSTALL AND MAINTAIN SWPPP.

GRADING and **DRAINAGE PLAN**

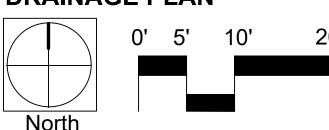

ACCESSIBLE PATH OF TRAVEL AS INDICATED ON PLAN IS A BARRIER FREE ACCESS PATH OF TRAVEL WITHOUT ANY ABRUPT LEVEL CHANGES EXCEEDING \(\frac{1}{2} \)" BEVELED AT 1:2 MAX. SLOPE, OR VERTICAL LEVEL CHANGES NOT EXCEEDING 1/4" MAX. AND AT LEAST 48" WIDE. SURFACE IS SLIP RESISTANT, STABLE, FIRM, AND SMOOTH. CROSS SLOPE DOES NOT EXCEED 2% AND SLOPE IN THE DIRECTION OF TRAVEL IS LESS THAN 5% UNLESS OTHERWISE INDICATED.



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Project

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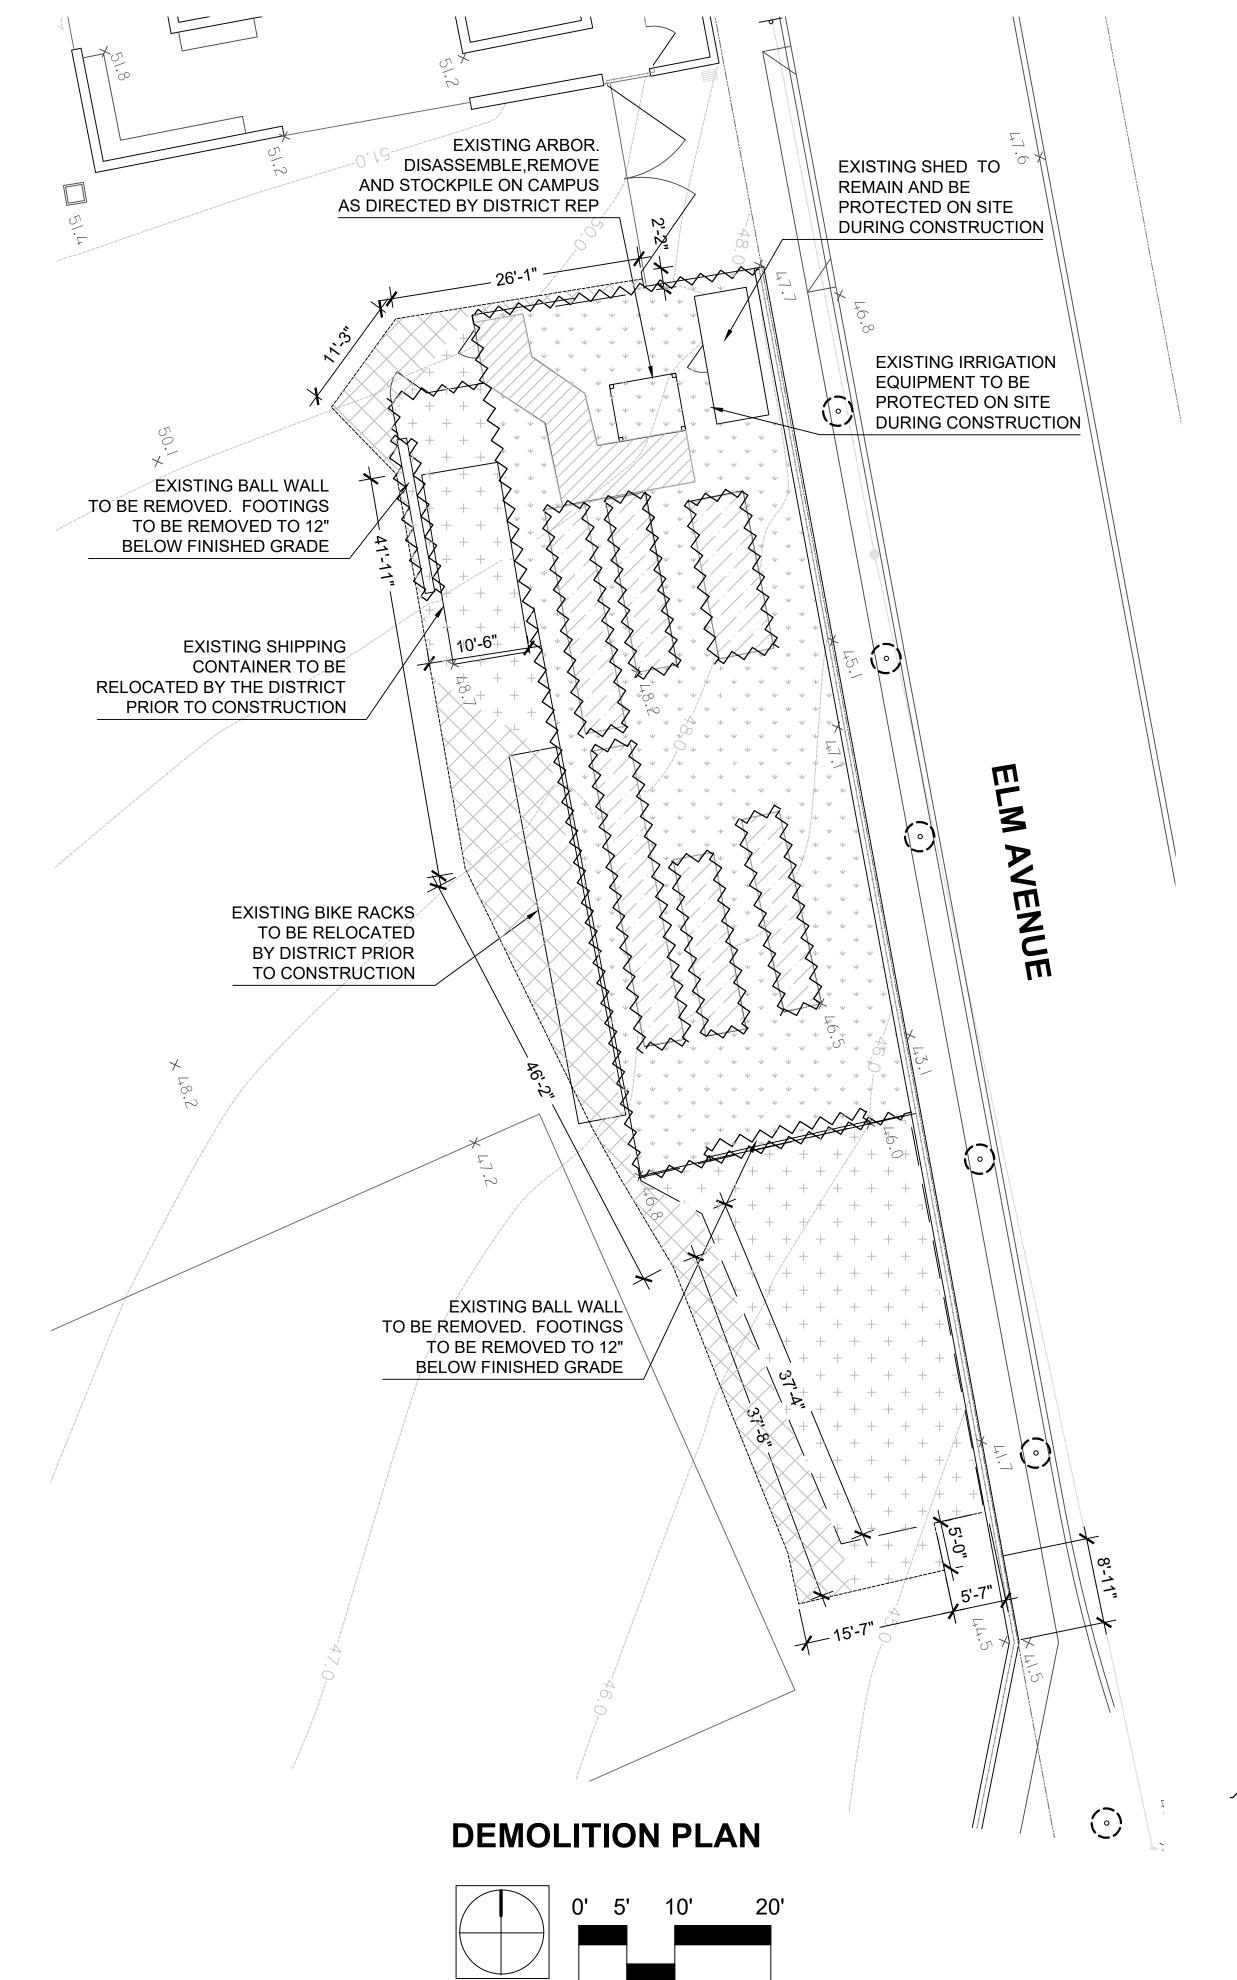
Drawing Title

GRADING and **DRAINAGE PLAN**

Date: February 15, 2019 Job #: 1807
Revisions

Sheet Number

G-1



EXISTING TREE TO

BE PROTECTED

2X4X8 AROUND

2" WIDE NYLON

48" HEIGHT ORANGE

SNOW FENCING

AROUND OUTSIDE

STRAPPING

OF 2X4'S.

ENTIRE PERIMETER

TREE PROTECTION NOTES

1. PROVIDE 2x4x8 'S 12" O.C, (MEASURED AT THE GROUND

PLANE), AROUND PERIMETER

2. PROVIDE 2" NYLON STRAP

AND NAIL TO EACH 2X4 WITH

1" LENGTH ROOFING NAIL.

3. PROVIDE 48" HEIGHT ORANGE 'SNOW FENCE'

AROUND BASE OF TREE

ROOFING NAILS PER 2X4.

PORTION OF THE TREE.

TO PROCEEDING WITH

DEMOLITION.

TREE PROTECTION

USING 2 - 1" LENGTH

TRUNK. NAIL FENCE TO 2X4'S

3. DO NOT NAIL PROTECTIVE FENCE DIRECTLY INTO ANY

4. TREE PROTECTION FENCE IS TO BE INSTALLED PRIOR

OF TREE TRUNK.

FOR STABILITY



- 1. CONTRACTOR SHALL SUPPLY ALL NECESSARY TEMPORARY FENCING TO SECURE THE JOB SITE AND STORAGE FOR EQUIPMENT DURING CONSTRUCTION OPERATONS. FENCING SHALL BE 8' MIN. HEIGHT CHAINLINK WITH WIND SCREEN FABRIC. LOCATION OF FENCING SHALL BE IN LOCATIONS SHOWN AND SHALL NOT IMPEDE PUBLIC ACCESS ON EXISTING SIDEWALKS.
- 2. CONTRACTOR SHALL MEET ONSITE WITH DISTRICT REPRESENTATIVE PRIOR TO DEMOLITION TO REVIEW LAYOUT.
- 3. CONTRACTOR SHALL NOTIFY DISTRICT REPRESENTATIVE OF ANY DISCREPANCIES BETWEEN THE PLANS AND SITE CONDITIONS PRIOR TO DEMOLITION.
- 4. CONTRACTOR SHALL SAWCUT PAVING AT ALL LOCATIONS WHERE NEW PAVING MEETS OLD PAVING.
- 5. ALL REFUSE RESULTING FROM DEMOLITION SHALL BE OFF HAULED AND DISPOSED OF IN A LEGAL AND PROPER MANNER, FOLLOWING ALL STATE AND LOCAL ORDINANCES.
- 6. PROVIDE WASTE REPORTS FOR ALL REFUSE.
- 7. CONTRACTOR TO VERIFY WITH TOWN ENGINEER THAT EXISTING IRRIGATION LINES HAVE BEEN CUT AND CAPPED PRIOR TO DEMOLITION IN LANDSCAPE AREAS.
- 8. CONTRACTOR TO EXERCISE EXTREME CAUTION WHEN WORKING NEAR EXISTING UTILITY LINES. CONTRACTOR TO CONTACT THE APPROPRIATE UTILITY AND TOWN ENGINEER IF UTILITY CONFLICTS OCCUR DURING DEMOLITION.
- 9. CONTRACTOR SHALL PROTECT ALL EXISTING IMPROVEMENTS NOT INDICATED FOR REMOVAL WITHIN THE PROJECT SITE AND IS RESPONSIBLE FOR REPLACEMENT OF ITEMS DAMAGED DURING THE INSTALLATION OF THE PROJECT AT THE CONTRACTORS EXPENSE, (LABOR, MATERIALS AND PROFIT INCLUDED).
- 10. CONTRACTOR IS RESPONSIBLE FOR RECORDING EXISTING CONDITIONS PRIOR TO COMMENCING AND IS TO PROVIDE A COPY OF RECORDED INFORMATION TO THE TOWN.
- 11. CONTRACTOR SHALL COORDINATED WITH TOWN STAFF AND PROVIDE SIGNS, BARRIERS AND PERSONNEL NECESSARY DURING PLAYGROUND CLOSURES TO CLEARLY COMMUNICATE DATES AND TIMES THAT CLOSURES ARE TO OCCUR.

DEMOLITION LEGEND

CLEAR AND GRUB LANDSCAPE AREA

CONCRETE PAVING, CURBS AND STEPS TO BE REMOVED

AC PAVING AND ROADBASE TO BE REMOVED TO SUBGRADE WITHIN NEW LIMITS OF GARDEN AREA

REMOVE AND REPLACE ASPHALT

EXISTING PLANTER SOIL, REMOVE AND STOCKPILE ON SITE

LIMIT OF SITE WORK,APPROXIMATE LOCATION OF TEMPORARY FENCING

SAWCUT EXISTING ASPHALT PAVING

EXISTING C.L.FENCE, WOOD HEADER, BALL WALL, AND PLANTERS TO BE REMOVED

EXISTING TREE TO BE PROTECTED SEE DETAIL 1, THIS SHEET



1005 A Street, Suite 305 San Rafael, California 94901

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Project

Bid # 2018 / 19
Park School
Garden/
Paving-Striping- 01

Mill Valley School District 411 Sycamore Ave. Mill Valley, CA 94941

Drawing Title


DEMOLITION PLAN

Date: February 15, 2019
Job #: 1807

Revisions

Sheet Number

D-1

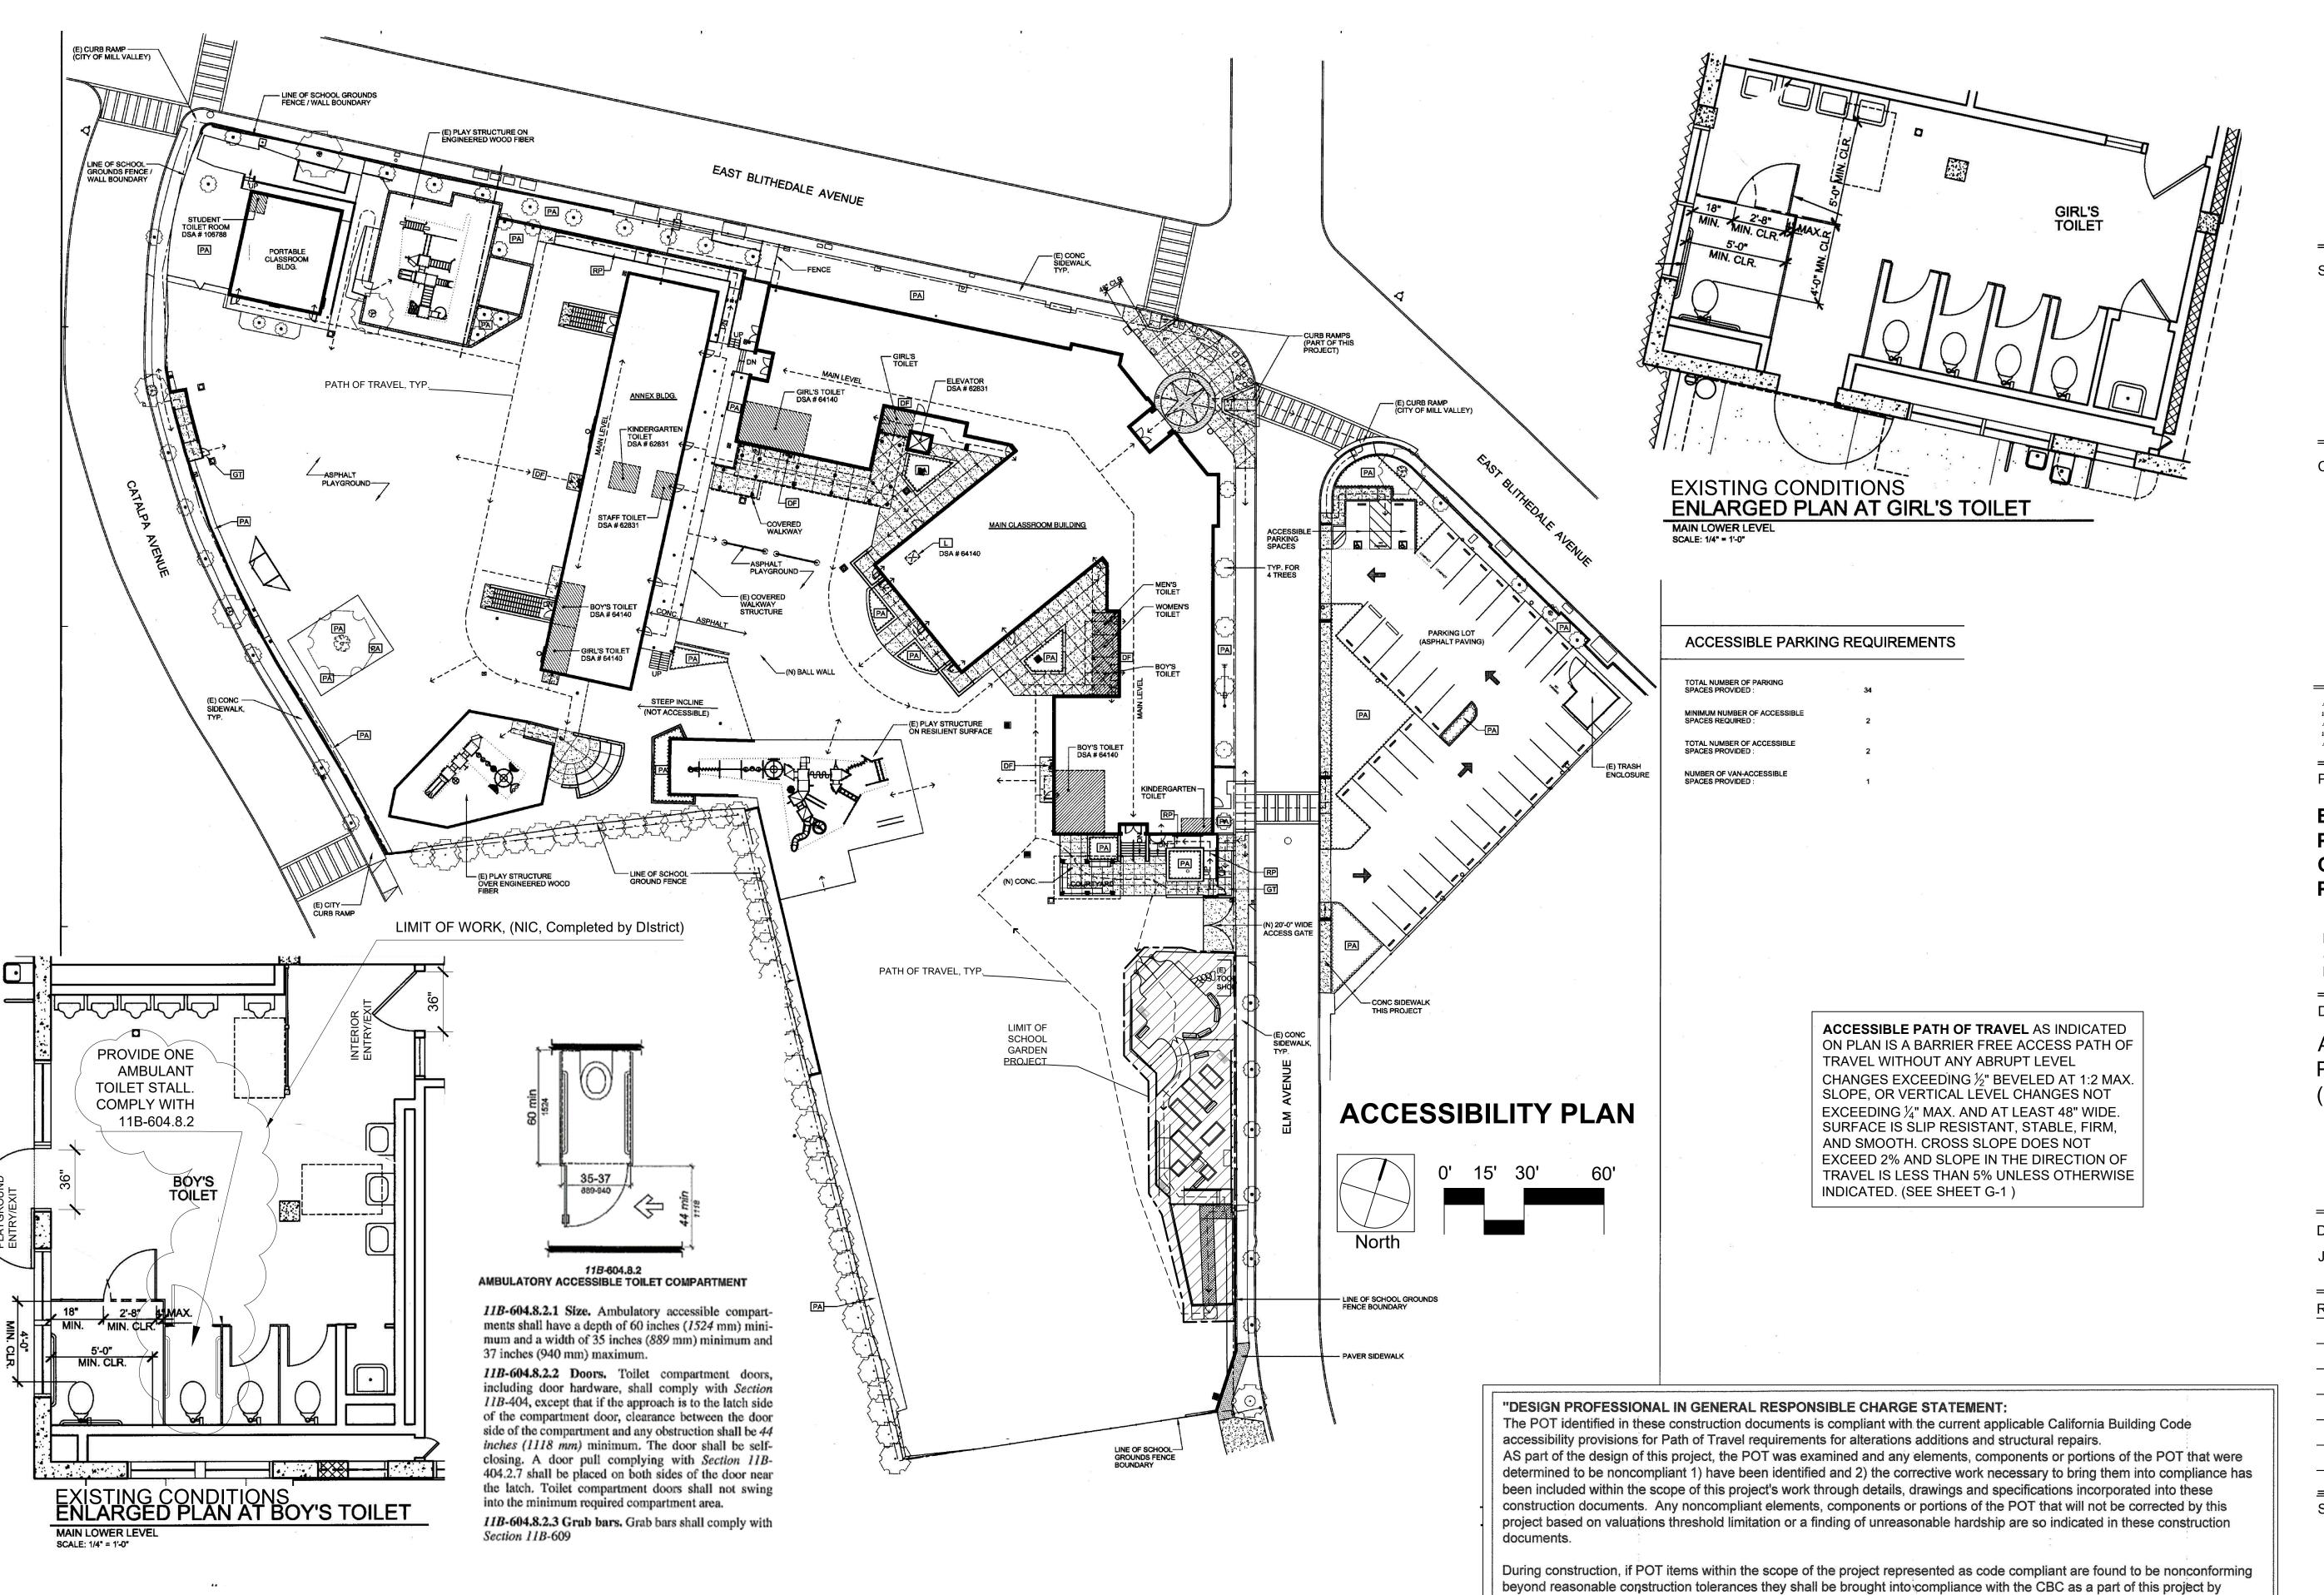

means of a construction change of document."



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Bid # 2018 / 19 Park School Garden/ Paving-Striping- 01

Mill Valley School District 411 Sycamore Ave. Mill Valley, CA 94941

Drawing Title

ACCESSIBLITY
PLAN
(reference only)

Date: February 15, 2019 Job #: 1807

Revisions

Sheet Number

A-1

CONSTRUCTION DOCUMENTS

FOR

PARK SCHOOL BID # 2018 /19

GARDEN / PAVING - STRIPING - 01

MILL VALLEY SCHOOL DISTRICT

411 SYCAMORE AVE.

MILL VALLEY, CA 94941



CALL TWO WORKING DAYS BEFORE YOU DIG

ABBREVIATIONS

ASPHALT CONCRETE

ADDITIONAL

ADJUSTABLE

AGGREGATE

ALTERNATE

ARCHITECT

AUTOMATIC

BITUMINOUS

CATCH BASIN

CAST IN PLACE+

CONTROL JOINT

CENTER LINE

CONCRETE MASONRY UNIT O.D.

CAST IRON

CEMENT

CLEAR

CONTR. CONTRACTOR

COORD. COORDINATE

CENTER

DOUBLE

DETAIL

DOWN

DRAWING

EXISTING

EXISTING

EACH SIDE

EACH WAY

ELEVATION

ENGINEER

EQUIPMENT

ETCETERA

EXTERIOR

FINISH

FROM

FOOT

FUTURE

GAUGE

GROUND

HEADER

HEIGHT

INCLUDE

INVERT

INCH

HOSE BIBB

HIGH POINT

HORIZONTAL

INSIDE DIAMETER

GALVANIZED

EXPANSION

FOUNDATION

ENCLOSURE

EACH

EQUAL

EXPANSION JOINT

DEMOLITION

DIAMETER

DIAGONAL

DIMENSION

DEPARTMENT

COLUMN

CONCRETE

CONNECTION

CONTINUOUS

CONSTRUCTION

DRINKING FOUNTAIN

ASPHALT

BUILDING

BOTTOM

BETWEEN

APPROX.APPROXIMATE

ADL

AGG.

AUTO.

BLDG.

C.I.

CEM

CLR.

CLMN

CONC.

CONN

CONST.

DEMO.

DEPT.

DET.

DIA.

DN.

EJ

E.S.

E.W.

ELEV.

ENGR

EQ.

EXP.

EXT.

FDN

FIN.

FR.

FT.

FUT.

GΑ

H.B.

H.P.

HT.

I.D.

IN.

INCL

HDR.

HORIZ.

EA.

DWG.

CL

JOINT

POUND

MATERIAL

MAXIMUM

MEDIUM

MINIMUM

MOUNTING

MATERIAL

NUMBER

NOMINAL

OPENING

OPPOSITE

PLYWOOD

PRECAST

QUANITY

REDWOOD

REQUIRED

REVISION

REFERENCE

REINFORCING

SQUARE FOOT

SCORE JOINT

SHEET METAL

SCHEDULE

SHEET

SIMILAR

SPACING

SQUARE

STATION

STEEL

STANDARD

STORAGE

SYSTEM

TOP OF

THICK

TYPICAL

VERTICAL

WITHOUT

WEIGHT

WITH

STRUCTURAL

SYMMETRICAL

TOP OF CURB

TOP OF PAVING

VERIFY IN FIELD

WHERE OCCURS

WELDED WIRE MESH

WATER PROOF

TOP OF WALL

TEMPORARY

SQUARE YARD

SPECIFICATION

RADIUS

PAIR

PENETRATION

PERFORATION

PROPERTY LINE

PREFABRICATED

ON CENTER

NEW

MECHANICAL

MANUFACTURER

MISCELLANEOUS

NOT IN CONTRACT

OUTSIDE DIAMETER

POLYVINYL CLORIDE

POUNDS PER SQUARE INCH

PRESSURE TREATED WOOD

REINFORCED CONCRETE PIPE

NOT TO SCALE

JT.

LB.

MFR.

MAT.

MAX

MED.

MIN.

MISC.

MTG.

MTL.

N.T.S.

NO.

O.C.

OPG.

OPP.

PSI

PVC

PLYWD.

PT.WD.

RAD.

RDWD.

REINF.

REQD.

REV.

S.F.

S.J.

S.M.

S.Y.

SCH.

SHT.

SIM

SQ.

STA

STD

STL.

SYM.

SYS.

T.C.

T.O.

T.O.P.

T.O.W.

TEMP.

THK.

TYP.

V.I.F.

W/

W.O.

W.P.

W/O

WT.

W.W.M.

VERT.

STRUCT

MECH

GENERAL NOTES

CONTRACTOR SHALL BE RESPONSIBLE FOR ALL LAYOUT AND MEASUREMENTS AS NOTED IN THE DRAWINGS AND SPECIFICATIONS. THE CONTRACTOR SHALL BE RESPONSIBLE FOR ALL SURVEYING AND FIELD ENGINEERING NECESSARY TO ESTABLISH THE LINES AND GRADE STAKES

- 2. BEFORE COMMENCING WORK UNDER THIS CONTRACT NOTIFY USA, UNDERGROUND SERVICE ALERT, AT 1-800-227-2600. THE CONTRACTOR SHALL DETERMINE THE EXACT LOCATION OF ALL EXISTING UTILITIES PIPES AND STRUCTURES BEFORE COMMENCING WORK AND AGREES TO BE FULLY RESPONSIBLE FOR ANY AND ALL DAMAGES WHICH MIGHT BE OCCASIONED BY THE CONTRACTOR'S FAILURE TO EXACTLY LOCATE AND PRESERVE SAID UTILITIES.
- CONTRACTOR SHALL NOT WILLFULLY PROCEED WITH CONSTRUCTION AS DESIGNED WHEN IT IS OBVIOUS THAT UNKNOWN OBSTRUCTIONS AND/OR GRADE DIFFERENCES EXIST THAT MAY NOT HAVE BEEN KNOWN DURING DESIGN. SUCH CONDITIONS SHALL BE IMMEDIATELY BROUGHT TO THE ATTENTION OF THE CITY REPRESENTATIVE. THE CONTRACTOR SHALL ASSUME FULL RESPONSIBILITY FOR ALL NECESSARY REVISIONS DUE TO FAILURE TO GIVE SUCH NOTIFICATION
- THE CONTRACTOR SHALL EXAMINE THE SITE, COMPARE IT WITH THE DRAWINGS AND SPECIFICATIONS, CAREFULLY EXAMINE ALL OF THE CONTRACT TO BE PERFORMED BEFORE ENTERING INTO THIS CONTRACT. NO ALLOWANCE SHALL SUBSEQUENTLY BE MADE ON BEHALF OF THE CONTRACTOR ON ACCOUNT OF AN ERROR ON HIS PART OR HIS NEGLIGENCE OR FAILURE TO AQUAINT HIMSELF WITH THE CONDITIONS OF THE SITE.
- THE CONTRACTOR SHALL FIELD VERIFY ALL JOB CONDITIONS AND DIMENSIONS SHOWN ON THE PLANS. ANY VARIATIONS THERE OF FROM THE DRAWINGS MUST BE REPORTED TO THE SCHOOL REPRESENTATIVE.
- CONTRACTOR IS RESPONSIBLE FOR ALL TRAFFIC CONTROL IN ACCORDANCE WITH CALTRANS "MANUAL OF TRAFFIC CONTROLS FOR CONSTRUCTION AND MAINTENANCE WORK ZONES".
- 7. UPON COMPLETION OF FINAL PUNCH LIST ITEMS, RECORD PLANS, PREPARED BY THE CONTRACTOR SHALL BE PROVIDED TO THE SCHOOL. PRIOR TO FINAL ACCEPTANCE, THE CONTRACTOR SHALL SIGN A STATEMENT OF COMPLIANCE VERIFY THAT ALL MATERIALS AND EQUIPMENT ARE INSTALLED PER PLAN AND ARE IN GOOD OPERATING ORDER. REFER TO SPECIFICATIONS FOR MAINTENANCE PERIOD REQUIREMENTS.
- 8. AN INVENTORY OF EXISTING IMPROVEMENTS SHALL BE SUBMITTED FOR ALL AREA. THIS IS TO DOCUMENT CONDITION OF EXISTING IMPROVEMENTS UPON THE CONTRACTOR'S ARRIVAL. INFORMATION SHALL INCLUDE: TREES, RETAINING WALLS, EXISTING CATCH BASINS, ROAD SIGNS, CURBING, UTILITY BOXES AND MANHOLES.
- 9. CONTRACTOR IS RESPONSIBLE FOR PROVIDING STORMWATER POLLUTION PREVENTION BMP'S AS REQUIRED BY THE STATE REGIONAL WATER QUALITY BOARD DURING THE COMPLETION OF THIS CONTRACT. CONTRACTOR SHALL HAVE ONSITE, MATERIALS NECESSARY TO PROVIDE STORMWATER RUNOFF PROTECTION DURING A STORM EVENT

ACCESSIBLE PATH OF TRAVEL AS INDICATED ON PLAN IS A BARRIER FREE ACCESS PATH OF TRAVEL WITHOUT ANY ABRUPT LEVEL CHANGES EXCEEDING 1/2" BEVELED AT 1:2 MAX. SLOPE, OR VERTICAL LEVEL CHANGES NOT EXCEEDING 1/4" MAX. AND AT LEAST 48" WIDE SURFACE IS SLIP RESISTANT, STABLE, FIRM, AND SMOOTH. CROSS SLOPE DOES NOT **EXCEED 2% AND SLOPE IN THE DIRECTION OF** TRAVEL IS LESS THAN 5% UNLESS OTHERWISE INDICATED.

PROJECT DIRECTORY PROJECT SCOPE

CLIENT MILL VALLEY SCHOOL DISTRICT 411 SYCAMORE AVE. MILL VALLEY, CA 94941 **CONTACT: JOHN BINCHI** PHONE: (415) 389 -7701

LANDSCAPE ARCHITECT: **ABEY ARNOLD ASSOCIATES** 1005 A STREET, SUITE 305 SAN RAFAEL, CA 94901 **CONTACT: PETER ARNOLD** PHONE: (415) 258-9580 (415) 258-9780

PAVING - STRIPING: CLEANING AND GRINDING OF EXISTING ASPHALT, REMOVING AND REPLACING OF ASPHALT, SLURRY SEALING, AND STRIPING INSTALLATION OF NEW VOLLEYBALL NET POST SLEEVES/FOOTINGS

GARDEN: **DEMOLITION and REMOVAL OF EXISTING** ASPHALT PAVING, PLANT MATERIAL, CONCRETE PAVING, FENCING. INSTALLATION OF PAVING, FENCING, GATES, SITE FURNISHINGS, PLANTERS, RAMP AND MULCH


BUILDING CODE 2016 CBC

ADAAG 2013

DRAWING LIST

NO. SHEET		SHEET TITLE		
1.	T-1	TITLE SHEET		
2.	A-1	ACCESSIBLITY PLAN		
3.	D-1	DEMOLITION PLAN		
4.	G-1	GRADING AND DRAINAGE PLAN		
5.	L-1	LAYOUT PLAN		
6.	L-2	CONSTRUCTION DETAILS		
7.	L-3	CONSTRUCTION DETAILS		
8.	L-4	CONSTRUCTION DETAILS		
9.	L-5	CONSTRUCTION DETAILS		
10.	P-1	PAVING PLAN		
11.	S-1	STRIPING PLAN		
12.	PD-1	STRIPING/PAVING DETAILS		
13.	PD-2	STRIPING/PAVING DETAILS		

PROJECT LOCATION

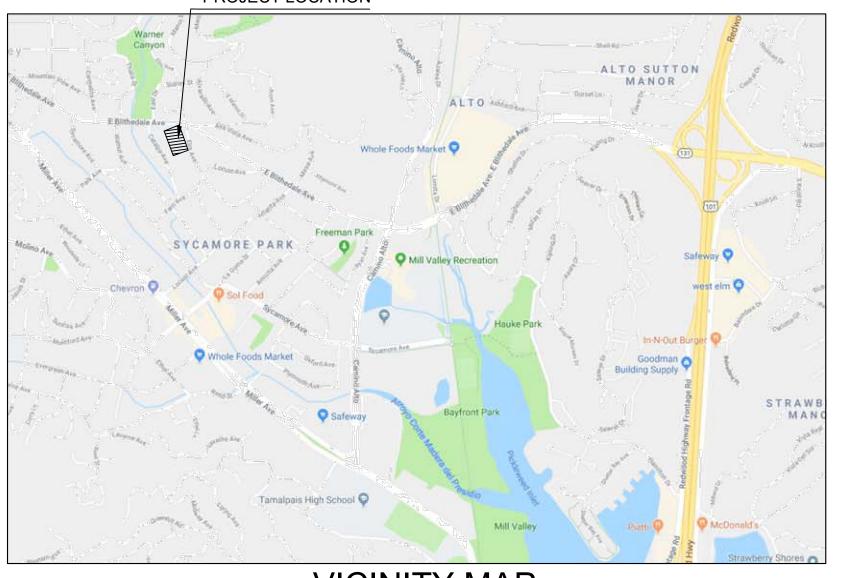





VICINITY MAP

"DESIGN PROFESSIONAL IN GENERAL RESPONSIBLE CHARGE STATEMENT:

The POT identified in these construction documents is compliant with the current applicable California Building Code accessibility provisions for Path of Travel requirements for alterations additions and structural repairs. AS part of the design of this project, the POT was examined and any elements, components or portions of the POT that were determined to be noncompliant 1) have been identified and 2) the corrective work necessary to bring them into compliance has

been included within the scope of this project's work through details, drawings and specifications incorporated into these construction documents. Any noncompliant elements, components or portions of the POT that will not be corrected by this project based on valuations threshold limitation or a finding of unreasonable hardship are so indicated in these construction documents.

During construction, if POT items within the scope of the project represented as code compliant are found to be nonconforming beyond reasonable construction tolerances they shall be brought into compliance with the CBC as a part of this project by means of a construction change of document.



1005 A Street, Suite 305 San Rafael, California 94907

Phone 415-258-9580 Fax 415/258-9780

CA License #2616

Seal

Consultants



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Project

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Mill Valley School District 411 Sycamore Ave. Mill Valley, CA 94941

Drawing Title

TITLE SHEET

Date: February 15, 2019 Job #: 1807

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Sheet Number